2018 IRC - IBC

2006 **IECC**

CALL TWO WORKING DAYS BEFORE YOU DIG

1-800-STAKE-IT (1-800-782-5348) YAVAPAI COUNTY

2018 IRC R311.3 There shall be a floor or landing on each side of the exterior door. The width of the landing shall not be less than the door served with a minimum distance of 36" measured in the direction traveled.

The inspector may require further clarification on stamped plans. This may include, but not limited to a special inspection and /or a cross section detail stamped and signed by the Designer/Architect/Engineer of record.

DEVELOPMENT SERVICES *PARCEL *OWNER/APPLICANT PERMIT #: PROJECT: **HOME OF MY OWN - 3 BED RIGHT (2020 PLANS)**

* Information required to be filled out by the applicant.

CAUTION

Yavapai County permitted building plans do not relieve the Owners or General Contractor from their responsibilities to conform to all adopted building codes. Every effort has been made to provide a thorough plan review, however plans may contain irregularities. If plans do not contain the proper information or details the Owner/General Contractor Shall Not proceed with the project until the issue has been resolved through Yavapai County and any professional involved in the project

Per 2018 IRCR309.1, R309.2, and IBC 406.3.3: Garage/ carport surfaces used for parking of vehicles shall be sloped to drain liquids to the main vehicle entry doorway or an approved drain

Effective April 20, 2006, **Fully shielded fixtures are** required for all exterior lamps

The mechanical equipment, design and system have been reviewed for the basic design ONLY. The HVAC contractor shall review the plans/ calculations to assure the design is adequate and complies with all applicable codes and installation

Yavapai County Ordinance, Section 112.6 THE ENGINEERED **Drainage across Property Lines. GEOTECHNICAL REPORT IS A** Drainage across property lines shall not exceed that

which existed prior to grading. Excess or concentrated PART OF THE PERMITTED drainage shall be contained on site or **DOCUMENTS, AND SHALL BE** directed to an approved drainage facility. Erosion of the **ONSITE AT ALL TIMES WITH THE** ground in the area of discharge shall be prevented by installation of non-erosive down-drains or PERMITTED PLANS. other devices.

Per Article 210.12 of the **2017 NEC**

Arc fault circuit interupters are required

A separate permit for alternative

electric source is required. The

alternative electric source

permit will need to be issued

and finalized before a building

final can be obtained

THE GAS PIPING INSTALLER SHALL **VERIFY THE SYSTEM IS OF SUCH SIZE** FOR THE MAXIMUM DEMAND AND TO **MEET EACH APPLIANCE INLET AT NOT** LESS THAN THE MINIMUM SUPPLY PRESSURE REQUIRED

Foam spray shall comply with the ES Reports

and applicable codes. It is the responsibility

of the owner and/or contractor(s) to review

reports and understand requirements before

application, Ignition/thermal barrier is

required unless otherwise exempt. Failure to

comply may cause additional cost to the

owner/contractor(s).

THIRD PARTY SPECIAL INSPECTIONS REQUIRED: (Third party special inspections are not in lieu of required building inspections.) YES

The following items require special inspections:

YAVAPAI

- SOILS CONDITION
- SOILS COMPACTION
- BOTTOM OF FOOTING COMPACTION
- AND OTHER INSPECTIONS REQUIRED BY THE GEOTECHNICAL ENGINEER.

Reports to be supplied to the Building Inspector

It is imperative that the owner /contractor print ALL permit documents from the online portal before inspection.

CAUTION:

Areas within Yavapai County are likely to have expansive, compressible, shifting or other unknown soils conditions. The building official may require a soils test to determine the soils characteristic at a particular location.

GENERAL GRADING NOTES:

Where the lot line walls, slopes, or other physical barriers prohibit 6" of fall within 10', drains or swales shall be provided to insure drainage away from the structure. **MAINTAIN MINIMUM 2:1 SLOPE**

The faces of cut and fill slopes shall be prepared and maintained to control against erosion. The protection for the slopes shall be installed as soon as practicable and prior to requesting final approval. NO GRADING WITHIN 2' OF PROPERTY LINES

aps

Applicant acknowledges that plans stamped by a

registrant will not be fully reviewed by staff and

that approvals are contingent upon favorable

field inspections. Should conditions in the field

prove non-conducive to code requirements,

significant delays may be realized. Applicant

attests that the sealed plans are in compliance

with all applicable codes and ordinances

Contact APS BEFORE you start construction; APS Prescott Office: 928-443-6797; Prescottcontroldesk@apsc.com APS Cottonwood Office: 928-646-8502; Verdecontroldesk@apsc.com

APS Wickenburg Office: 602-371-6200; Wickenburg controldesk@apsc.co

The property owner shall be responsible to verify fire sprinkler requirements with the governing fire district

Provide at least one window or exterior door approved for emergency escape or rescue for every room used for sleeping purposes. 2018 IRC R310.1

IMPORTANT! Footings will not be

Interconnected smoke detectors are required for this project per **2018 IRC R314.3.1. Each sleeping** room, outside each sleeping room and on each floor level.

APPROVAL IS SUBJECT TO FIELD INSPECTION AND COMPLIANCE WITH **ALL RELEVANT CODES,** LAWS AND ORDINANCES

RAIN GUTTERS & DOWNSPOUTS ARE REQUIRED

Positive drainage away from the structure is required. Refer to the geotechnical report for an additional requirements

inspected until the property corners are properly pinned. flagged and easily identifiable to the building inspector.

Slab insulation shall be approved for the under slab application. Provide an ES No slab grade or floor framing Report and manufacturer's specifications if not using the pre-approved products inspections will be conducted

- 1. Extruded polystyrene insulation Dow square edge (Blue)
- 2. Extruded polystyrene Owen corning Foamular 250 (Pink)

Per 2018 YCABC Ordinance 2014-1 Section 110.3.4: **Pre-slab inspections are required**

without compaction reports.

Reviewed for Design Criteria Only

/

Truss calculations to be on site at the time of frame inspection

BIG STAMP

DEVELOPMENT SERVICES

JEREMY DYE, ASSISTANT DIRECTOR

CARRIE HOLMES, CHIEF BUILDING OFFICIAL

DAVID C. WILLIAMS, DIRECTOR

8 BEDR

4

3

SHEET NO:

BOARD OF SUPERVISORS

CRAIG BROWN, CHAIRMAN - DISTRICT 4 JAMES GREGORY, MEMBER - DISTRICT 2 HARRY B. OBERG, MEMBER - DISTRICT 1 DONNA G. MICHAELS, Ph.D., MEMBER - DISTRICT 3 MARY MALLORY, VICE-CHAIR - DISTRICT 5



Single-Family Housing THREE BEDROOM / TWO BATH - RIGHT PARKING

YAVAPAI COUNTY, ARIZONA

1015 Fair Street Prescott, Arizona

GENERAL NOTES

1. DUE TO REPROGRAPHIC PROCESS, THESE PLANS MAY NOT BE SCALED FROM THE WORKING DRAWINGS.

2. BEFORE ORDERING ANY MATERIALS OR STARTING ANY WORK, CONTRACTORS SHALL VERIFY ALL MEASUREMENTS AND EXISTING CONDITIONS AT THE SITE AND SHALL BE RESPONSIBLE FOR THE CORRECTNESS OF THE SAME. ANY DEVIATION AND/OR UNSAFE OR UNREGULATED CONDITIONS SHALL BE BROUGHT TO THE ATTENTION OF YAVAPAI COUNTY DEVELOPMENT SERVICES.

3. GENERAL CONTRACTOR TO VERIFY AND LOCATE ALL UTILITY STUB OUTS AND MAINS BEFORE BEGINNING CONSTRUCTION OF PROJECT.

4. GENERAL CONTRACTOR TO VERIFY THE REMOVAL AND/OR REPLANTING OF LANDSCAPE IF THE CONDITION OCCURS OVER THE PROJECT SITE. 5. DAMAGE TO SITE, UTILITIES, OR NEWLY BUILT IMPROVEMENTS, NOT DESIGNED FOR REMOVAL, SHALL BE THE RESPONSIBLITY OF THE GENERAL CONTRACTOR INVOLVED, AND SHALL BE REPAIRED OR REPLACED AT THE

EXPENSE OF THE SAME. 6. VERIFY UNIFORMITY OF ALL FRAMING SO AS TO CREATE A SMOOTH, REGULAR FINISH WITH NO IRREGULARITIES.

1. IT IS THE RESPONSIBILITY OF THE GENRAL CONTRACTOR. TO THOROUGHLY REVIEW THE PLANS AND TO NOTIFY YAVAPAI COUNTY DEVELOPMENT SERVICES OF ANY DISCREPANCIES. YAVAPAI COUNTY, NOR THE ARCHITECT-OF-RECORD, WILL NOT BE RESPONSIBLE FOR MATERIALS IMPROPERLY ORDERED OR INSTALLED

8. FAILURE BY THE GENERAL CONTRACTOR, OR SUB-CONTRACTORS, TO AQUAINT THEM-SELVES WITH ALL AVAILABLE INFORMATION CONCERNING THIS PROJECT SHALL NOT RELIEVE THEM OF THE RESPONSIBILITY TO PERFORM THEIR

- WORK PROPERLY. 9. APPROVAL OF ALL CONSTRUCTION IS SUBJECT TO FIELD VERIFICATION BY YAVAPAI COUNTY PERSONELL.
- 10. EVERY SLEEPING ROOM SHALL HAVE AT LEAST ONE (1) OPERATING WINDOW, OR DOOR, FOR EMERGENCY EGRESS, OPEN DIRECTLY TO A STREET, ALLEY, OR YARD.
- 11. ALL INTERIOR WALL, AND CEILING FINISHES, SHALL BE TAPED, TEXTURED, AND PAINTED 1/2" DRYWALL. PROVIDE 'GREENBOARD' BEHIND ALL TUB ENCLOSURES.

INDEX TO DRAWINGS

CS	COVER SHEET
A-1.0	PROJECT INFO / FLOOR PLAN / OPENING SCHEDULES
A-1.1	GARAGE ALTERNATE SHEET
A-2.0	FOUNDATION PLAN / DETAILS
A-3.0	ROOF FRAMING PLAN / DETAILS
A-4.0	EXTERIOR ELEVATIONS / BLDG. SECTION
ME-1	HVAC / ELECTRICAL PLANS

PROJECT INFORMATION

ALL WORK SHALL CONFORM TO ALL YAVAPAI COUNTY ADOPTED CODES, ORDINANCES AND POLICIES, INCLUDING BUT NOT LIMITED TO THE FOLLOWING: 2018 INTERNATIONAL RESIDENTIAL CODE (IRC) 2018 INTERNATIONAL PLUMBING CODE (IPC) 2018 INTERNATIONAL MECHANICAL CODE (IMC) 2017 NATIONAL ELECTRIC CODE (NEC)

2006 INTERNATIONAL ENERGY CONSERVATION CODE (IECC) LIVABLE: 1,300 SQ. FT. COVERED ENTRY: 65 SQ. FT. 400 SQ. FT. CARPORT: STORAGE: 62 SQ. FT.

TOTAL UNDER ROOF: 1,827 SQ. FT. OCCUPANCY: R-3 (Single-Family Residential)

CONSTRUCTION TYPE: V-B

12/08/2021

YAVAPAI COUNTY BUILDING DEPT. () REVIEWED FOR CODE COMPLIANCE () REVIEWED AS NOTED WITH CORRECTION

ENGINEERING REVIEWED FOR DESIGN CRITERIA ONLY THE ISSUANCE OF A PERMIT BASED ON PLANS, SPECIFICATIONS, AND OTHER DATA, SHALL NOT PREVENT THE BUILDING OFFICIAL FROM THEREAFTER REQUIRING THE CORRECTION OF ERRORS IN SAID PLANS, SPECIFICATIONS, AND OTHER DATA, OR FROM PREVENTING BUILDING OPERATIONS BEING CARRIED ON THEREAFTER, WHEN IN VIOLATION OF THIS CODE OR ANY OTHER ORDINANCES OF THIS JURISDICTION - SEC. 105.4

EFFECTIVE APRIL 20, 2006 **FULLY SHIELDED FIXTURES ARE** REQUIRED FOR ALL EXTERIOR LAMPS

POSITIVE DRAINAGE AWAY FROM THE STRUCTURE IS REQUIRED

Building Inspector ADDITONAL REQUIREMENTS

PER GEOTECH REQUIREMENTS 12/08/2021 Luis Tamayo SPECIAL INSPECTION REQUIRED Reports to be supplied to

CAUTION Yavapai County permitted building plans do not relieve the Owners or General Contractor from their responsibilities to conform to all adopted building codes. Every effort has been made to provide a thorough plan review, however plans may contain irregularities. If plans do not contain the proper information or details the Owner/General Contractor Shall Not proceed with the project until

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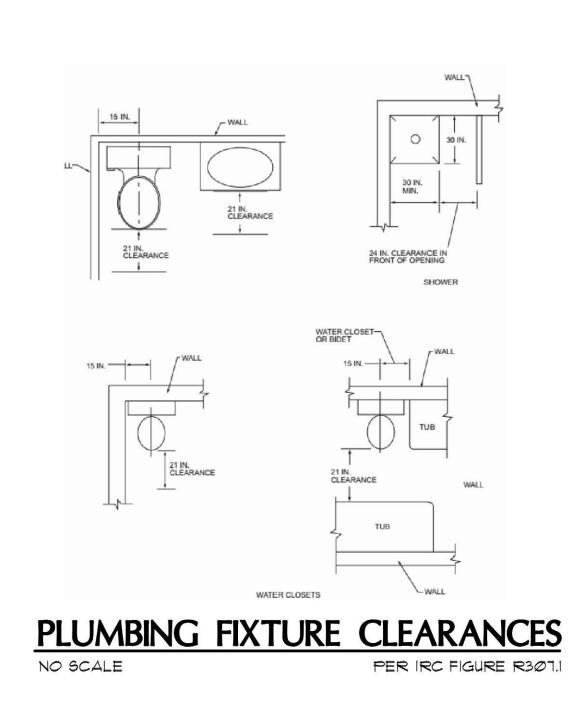
Yavapai County Ordinance, Section 112.6


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REVIEWED FOR DESIGN CRITERIA ONLY


REFER TO THE GEOTECHNICAL REPORT FOR ANY

PROPERTY OF YAVAPAI COUNTY, AZ



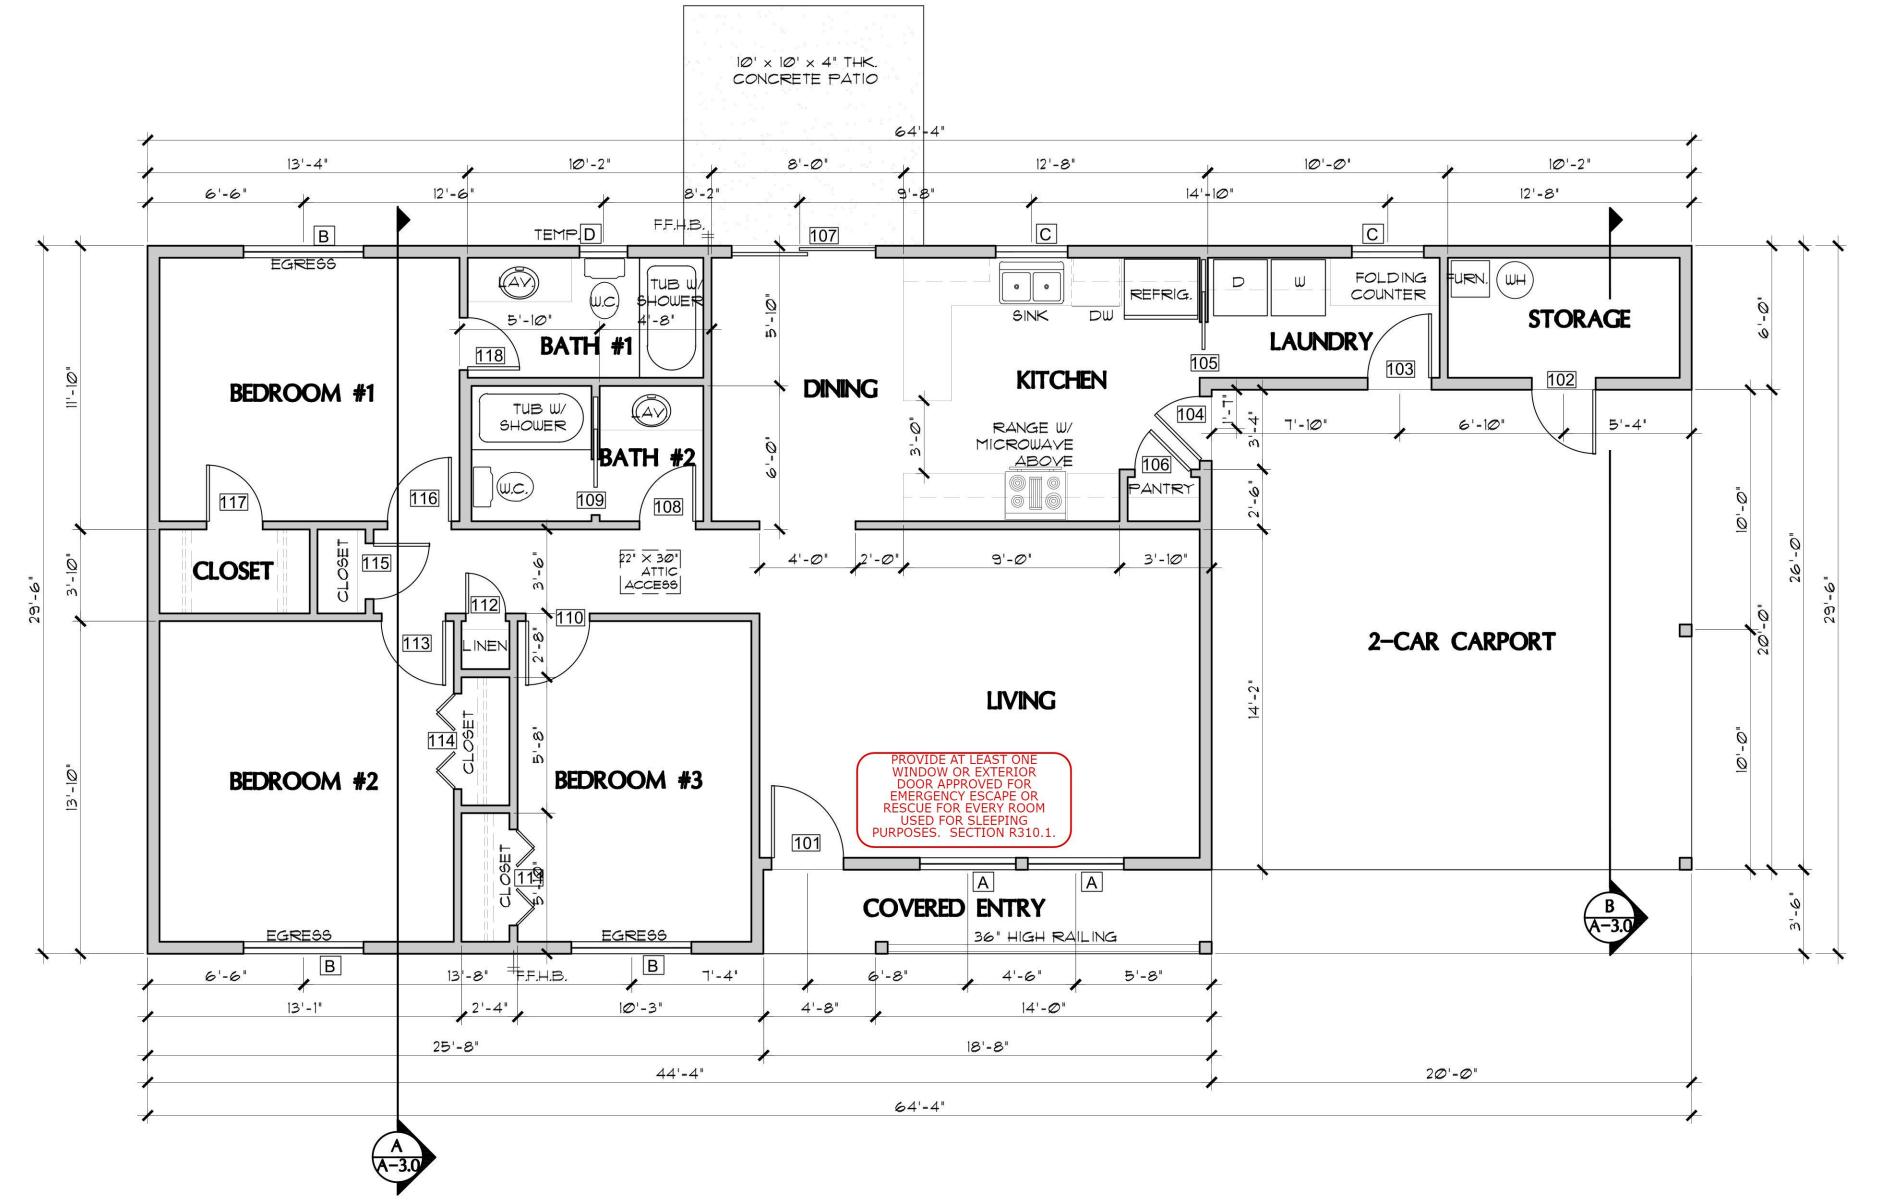

FLOOR PLAN (see sheet A-1.1 for Garage Alternate) SCALE: 1/4" = 1'-0"

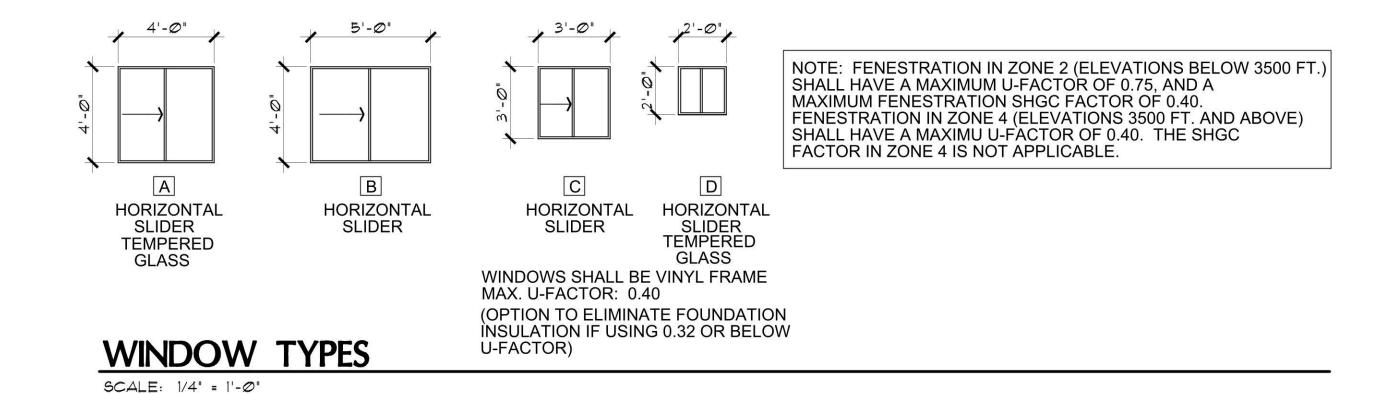

DR. #	SIZE			DOOR TYPE	
	W.	H.	T.		REMARKS
101	3'-0"	6'-8"	1-3/4"	EXTERIOR 6-PANEL SOLID-CORE WOOD	
102	2'-8"	6'-8"	1-3/4"	EXTERIOR FLUSH SOLID-CORE WOOD	
103	2'-8"	6'-8"	1-3/4"	EXTERIOR FLUSH SOLID-CORE WOOD	
104		6'-8"	1-3/4"	2-PANEL SOLID-CORE WOOD W/ TEMPERED GLASS VISION PANEL	SELF-CLOSING & SELF-LATCHING PROVIDE THRESHOLD AND WEATHERSTRIPPING
105	2'-4"	6'-8"	1-3/8"	INTERIOR 4-PANEL SLIDING POCKET DOOR	
106	3'-0"	6'-8"	1-1/2"	INTERIOR 4-PANEL HOLLOW CORE	
107	6'-0"	6'-8"	-	EXTERIOR SLIDING-GLASS PATIO DOOR	
108	5'-0"	6'-8"	1-1/2"	INTERIOR 4-PANEL HOLLOW CORE	
109	5'-0"	6'-8"	1-3/8"	INTERIOR 4-PANEL SLIDING POCKET DOOR	
110	2'-8"	6'-8"	1-1/2"	INTERIOR 4-PANEL HOLLOW CORE	
111	4'-0"	6'-8"	1-1/8"	INTERIOR 4-PANEL BI-FOLD	
112	1'-8"	6'-8"	1-1/2"	INTERIOR 4-PANEL HOLLOW CORE	
113	2'-8"	6'-8"	1-1/2"	INTERIOR 4-PANEL HOLLOW CORE	
114	4'-0"	6'-8"	1-1/8"	INTERIOR 4-PANEL BI-FOLD	
115	2'-4"	6'-8"	1-1/2"	INTERIOR 4-PANEL HOLLOW CORE	
116	2'-8"	6'-8"	1-1/2"	INTERIOR 4-PANEL HOLLOW CORE	
117	2'-4"	6'-8"	1-1/2"	INTERIOR 4-PANEL HOLLOW CORE	
118	2'-4"	6'-8"	1-1/2"	INTERIOR 4-PANEL HOLLOW CORE	



Date Drawn by:

Scale

Revisions:

Chk'd by : MFR

: AS NOTED

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Scales as stated hereon are valid on the original drawing only. Contractor shall carefully review all dimensions and conditions shown hereon and at once report to the Architect any error, inconsis—

tancy or omission he may discover.


MARK F


PARKING


PROJECT INFO / OPENING BEDROOM / 2 BA

SHEET NO:


A-1.0

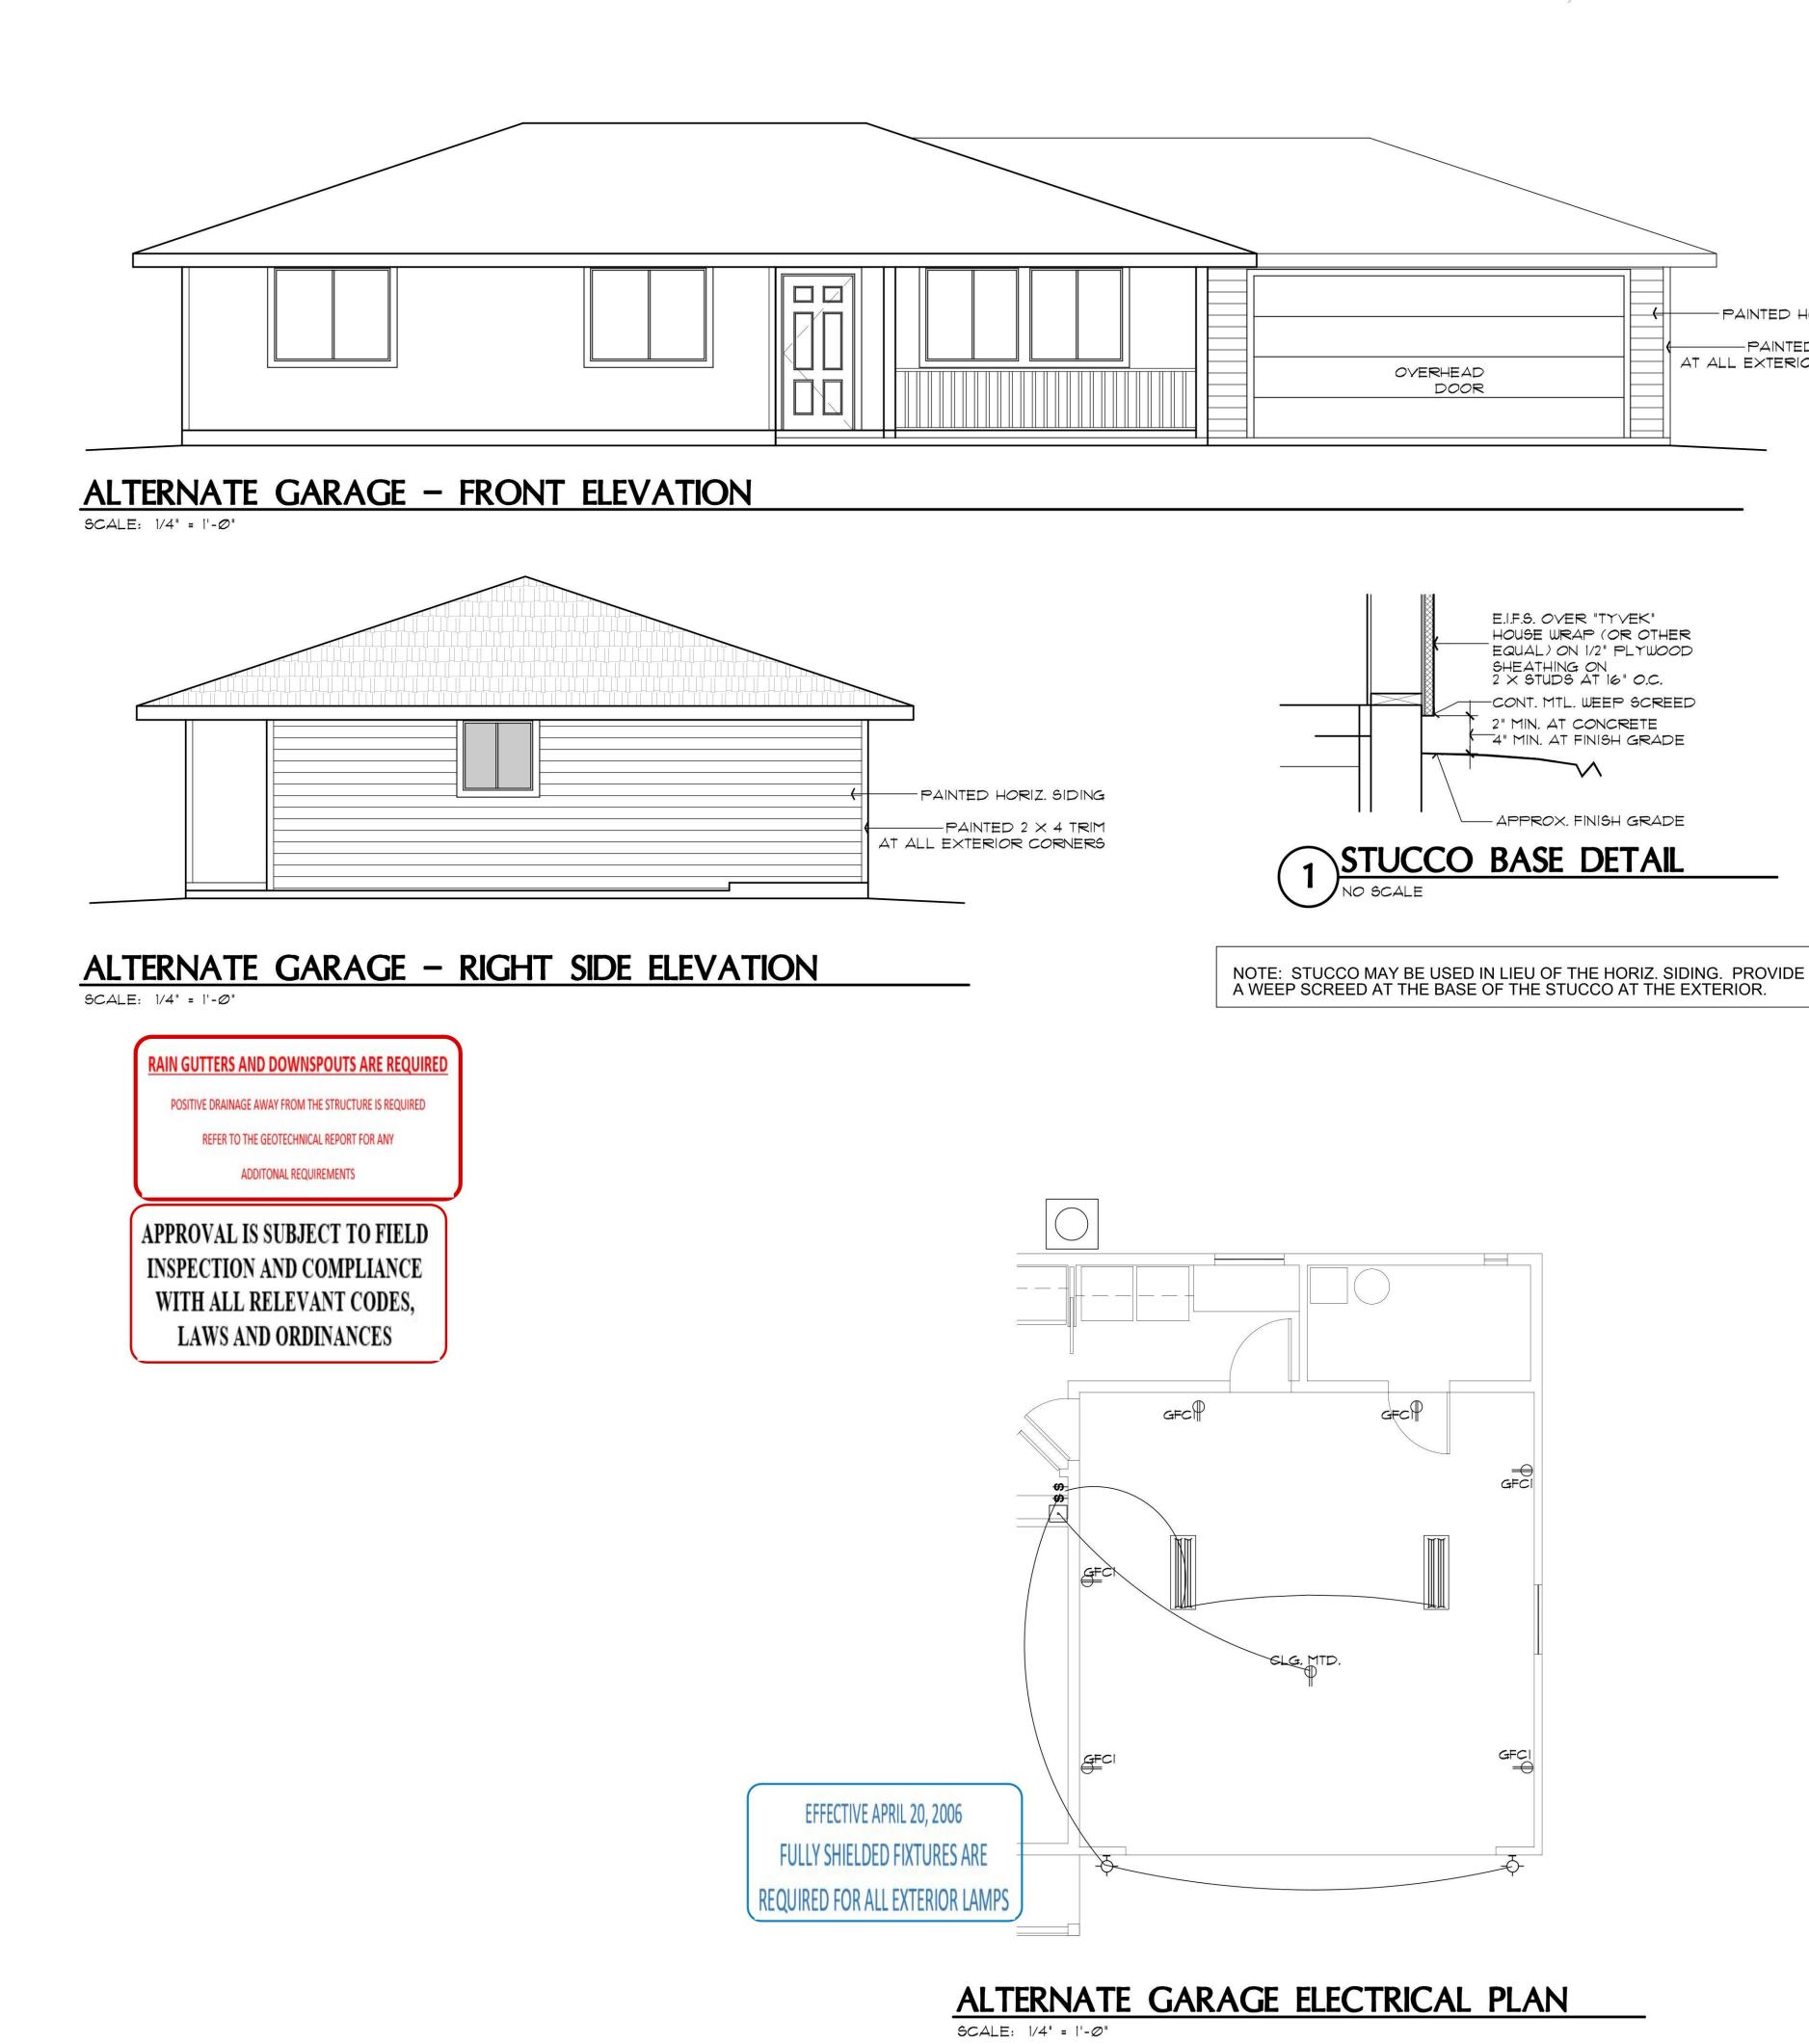

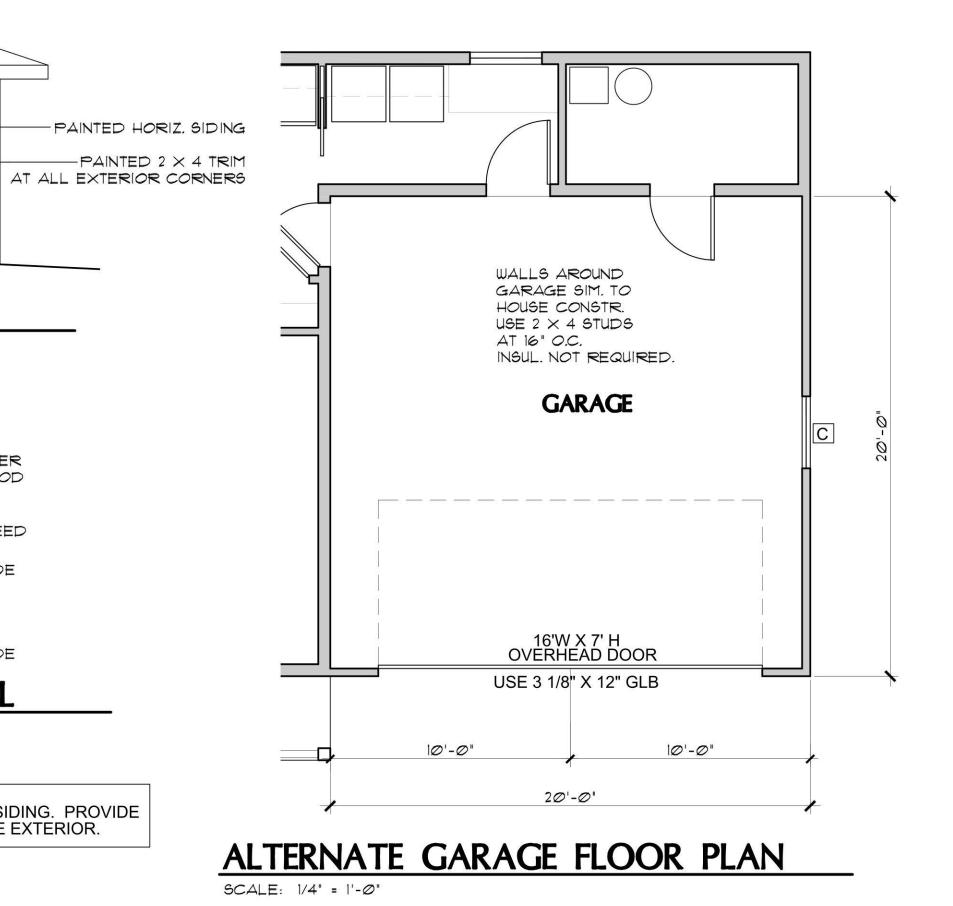

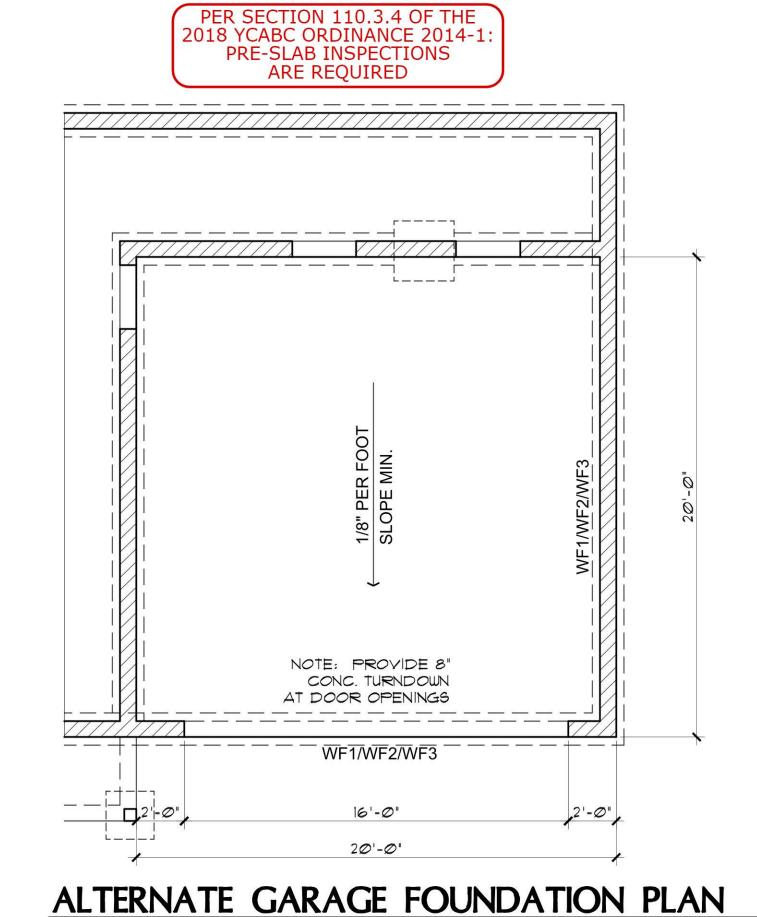

SCALE: 1/4" = 1'-0"

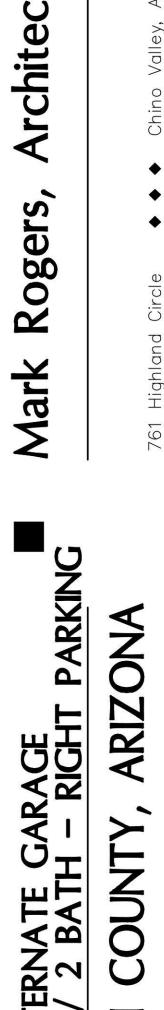

Drawn by: MFR Chk'd by: MFR

Scale : Revisions:

PLL

: AS NOTED

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AEDROOM SHEET NO:

YAVAPA


PROPERTY OF YAVAPAI COUNTY


THE ENGINEERED GEOTECHNICAL REPORT

- 2. SIMPSONS H2.5A HANGERS TO BE APPLIED @ ALL TRUSS
- 3. PROVIDE A MINIMUM OF 1 SQ. FT. OF ATTIC VENTILATION FOR EACH 150 SQ. FT. OF ATTIC SPACE.
- 4. ALL PLYWOOD SHEATHING STD. GRADE 5/8" CDX NAIL 8d @ 6" EDGES -12" FIELD STAGGER JOINTS.
- 5. SUPPORTED MEMBERS OF G.L.B. & GIRDERS OR OTHER CONCENTRATED LOADS SUPPORTED BY WALL OR PIER SHALL HAVE BEARING AT LEAST AS WIDE AS THE ROOF
- 6. ROOF PITCH 4:12 (TYP.).


ROOF NOTES

- 7. OVERHANGS TO BE 24".
- 8. FURNACE IN ATTIC: PROVIDE A 24" SOLID PASSAGEWAY TO CONTROL SIDE OF APPLIANCE AND A 30" SERVICE SPACE ON THE CONTROL SIDE OF THE APPLIANCE (REQUIRED FOR ATTIC MOUNT FURNACES)
- 9. ALL OVER FRAMING REQUIRES SLEEPER OR BLOCKING AND COLLAR TIES
- 10. ALL RAFTERS SHALL BE DOUGLAS FIR #2 (SIZE PER PLAN) ALL STUDS SHALL BE HEM FIR #2 (SIZE PER PLAN)
- 11. PROVIDE TEMP. BRACING, SHORING AND GUTTING TO AVOID EXCESSIVE STRESSES AND TO HOLD STRUCTURAL ELEMENT IN PLACE DURING ERECTION.
- 12. PROVIDE MFR'S, DRAWINGS AND ENGINEERING FOR ALL PRE-FAB TRUSSES

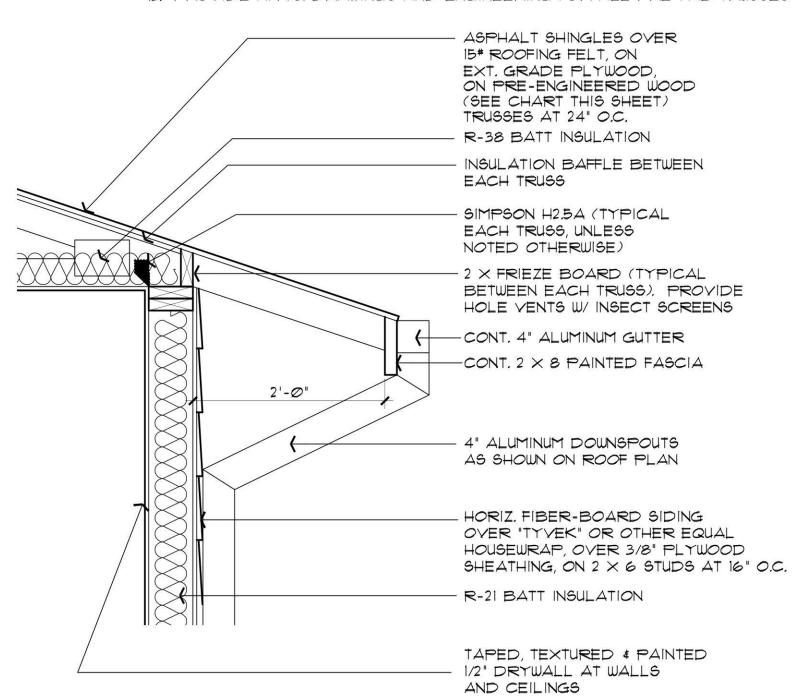

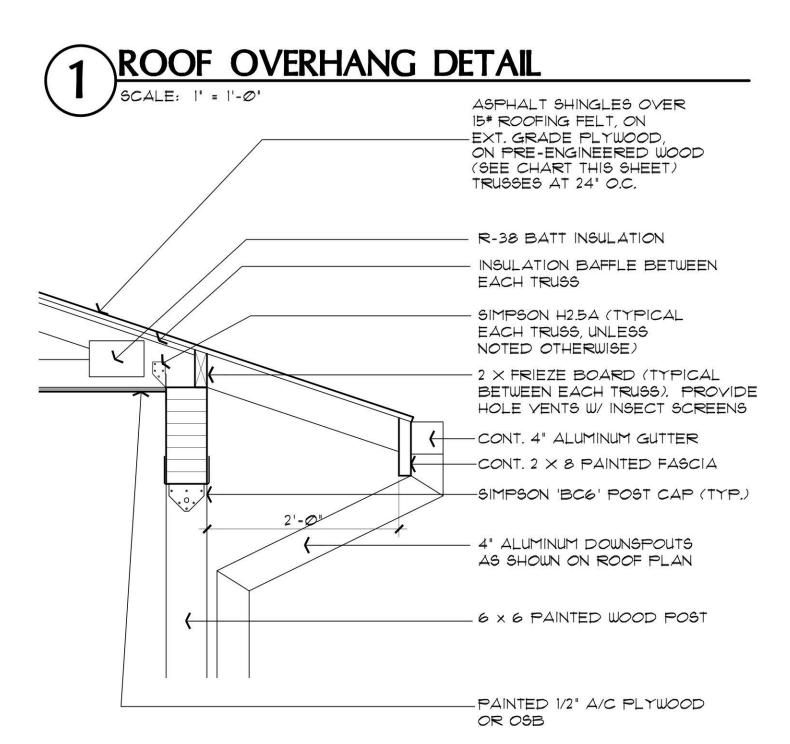

ROOF OVERHANG AT CARPORT BEAM DETAIL SIM. CONDITION AT FRONT ENTRY

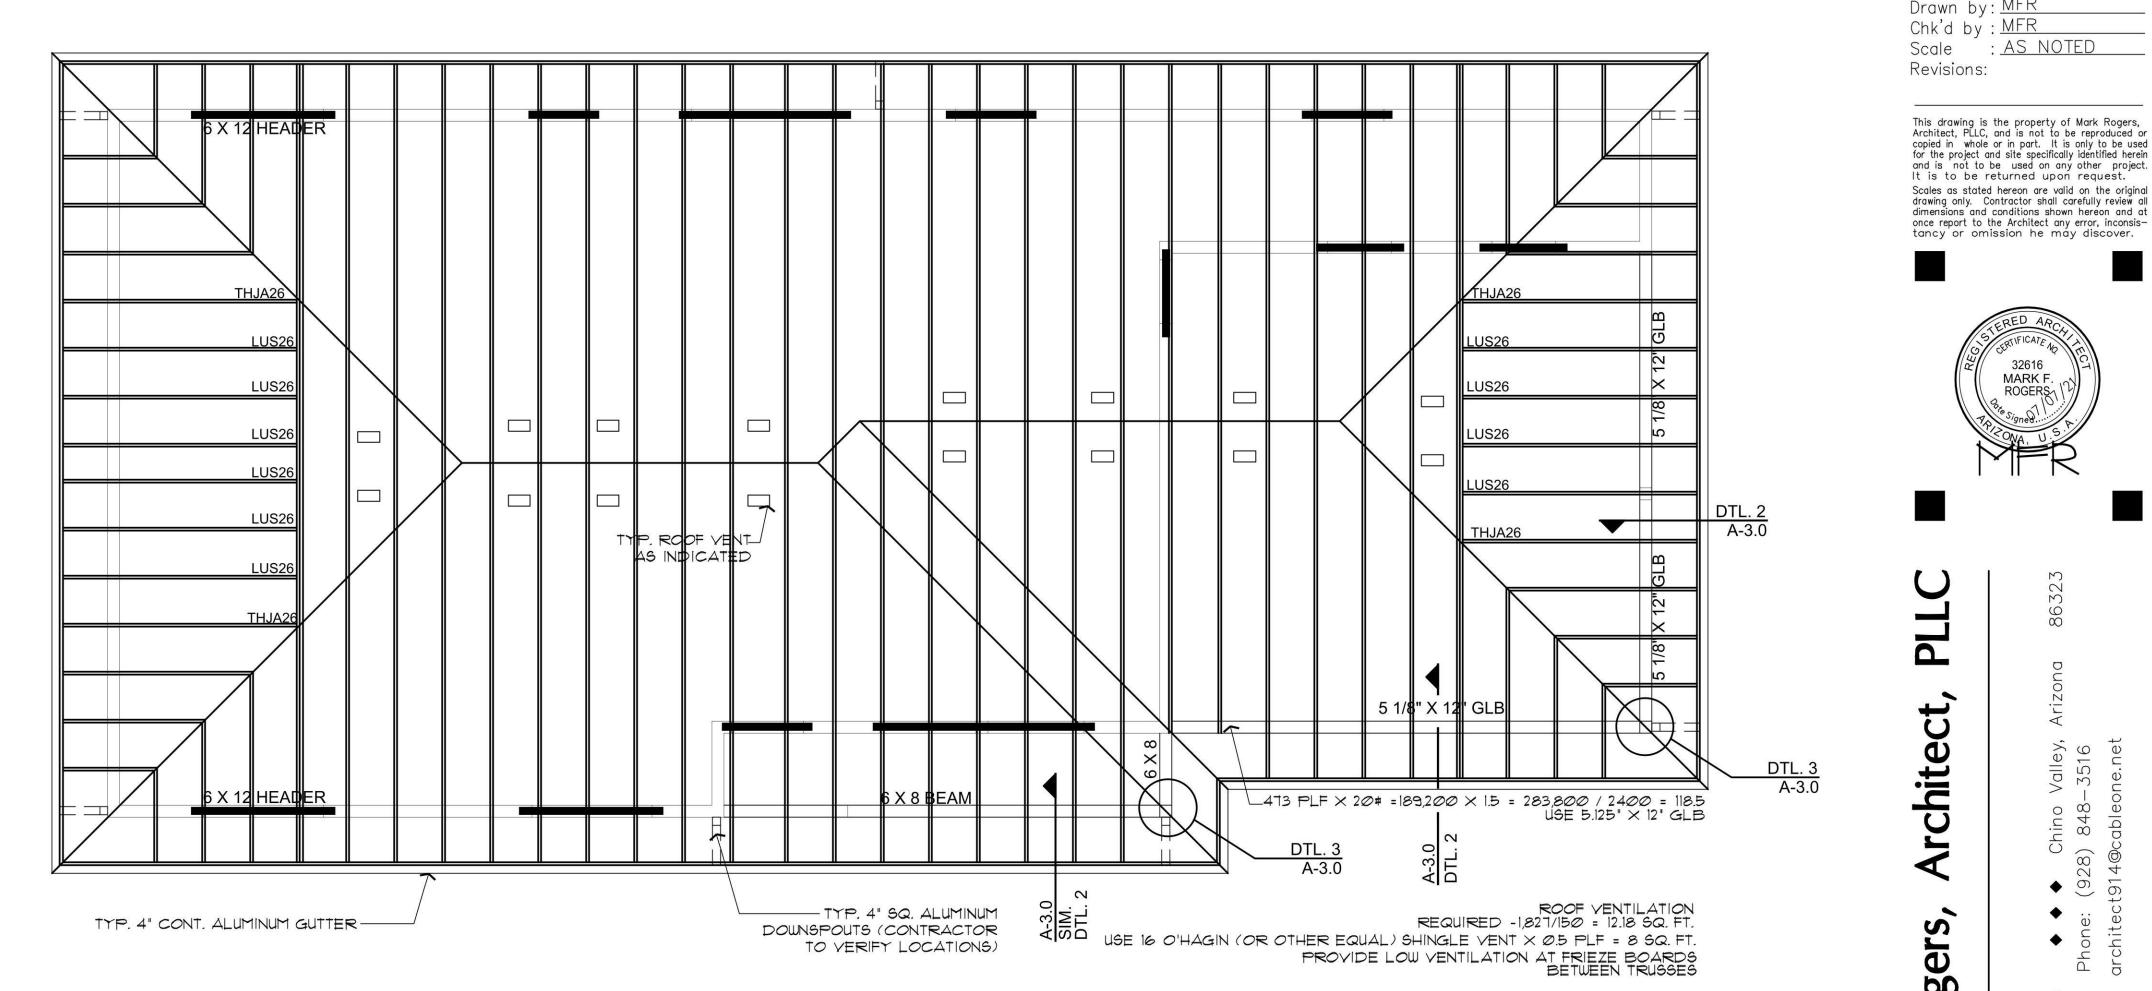

ROOF FRAMING PLAN

SCALE: 1/4" = 1'-0"

TO BE ON SITE AT TIME OF INSPECTION

APPROVAL IS SUBJECT TO FIELD INSPECTION AND COMPLIANCE WITH ALL RELEVANT CODES, LAWS AND ORDINANCES


NOTE: ALL OPENING HEADERS AT EXT. WALLS TO BE 6 X 8 UNLESS NOTED OTHERWISE

NOTE: PROVIDE PANEL EDGE SUPPORT FOR NARROW-WIDTH ROOF SHEATHING PER APA TECHNICAL REPORT #R275A.


NOTE: TRUSS-TO-GIRDER DOUBLE STUDS UNDER | CONNECTIONS TO BE TWO-PLY GIRDER TRUSSES SIMPSON HTU26 OR OTHER

Yavapai County Snow Load by Elevation

ELEVATION	SNOW LOAD	FOOTING DEPTH	ROOF SHEATHING
5000 ft. and Below	20 PSF	12" below 4500 ft. 18" above 4500 ft.	1/2"
5001 ft. to 5900 ft.	30 PSF*	18"	1/2"
5901 ft To 6200 ft.	40 PSF*	18"	½" or 5/8" With tile over 60#TL
6201 ft. to 6500 ft.	45 PSF*	18"	5/8"
Over 6501 ft.	50 PSF*	24"	5/8"

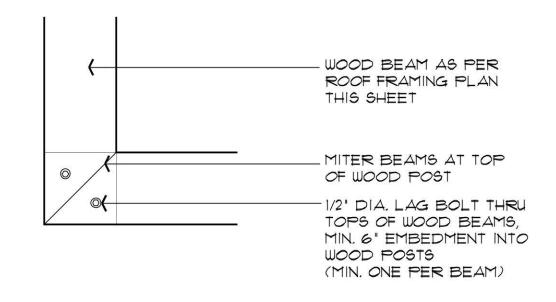

PLAN VIEW - MITERED BEAM AT CORNER POSTS CONNECTION

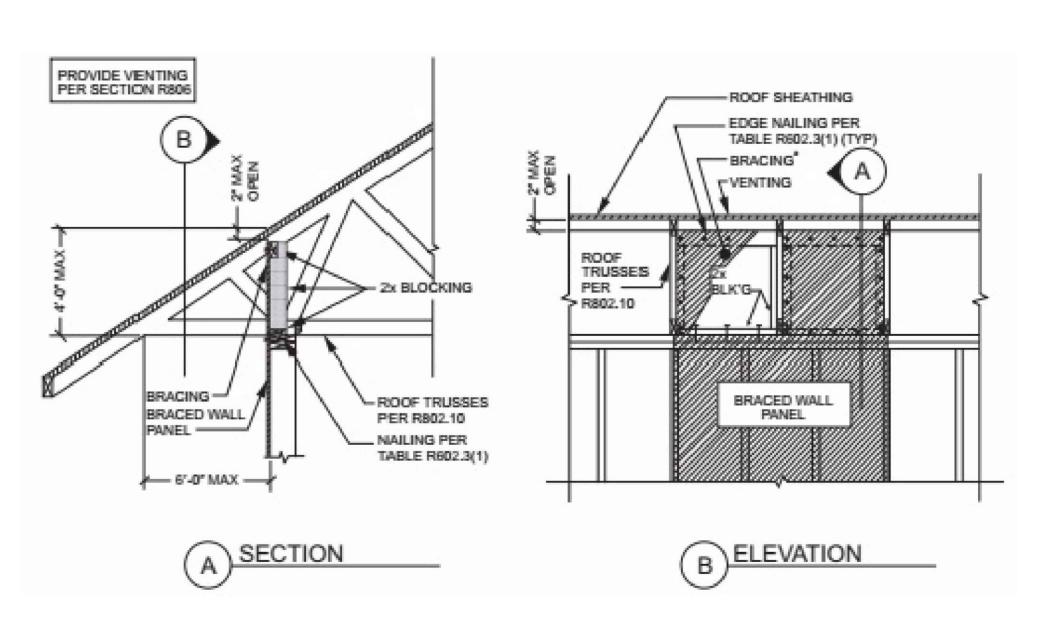

BRACED WALL PANEL CONNECTION OPTION

AT PERPENDICULAR ROOF TRUSSES

2018 IRC FIGURE
2018 IRC FIGURE

2018 IRC FIGURE R602.10.8.2(3)

REVIEWED FOR DESIGN CRITERIA ONLY

PROPERTY OF YAVAPAI COUNTY. AZ

Marl

PARKING

S. RIGHT

MING PI DETAIL: ATH - I

00F 2 B/

84

: AS NOTED

32616

ROGERS_

MARK F

ARIZONA

BEDROO SHEET NO:

X

A - 3.0

Date Drawn by

Chk'd by : MFR

PROPERTY OF YAVAPAI COUNTY, AZ

- DOORBELL BUTTON --- TELEPHONE OUTLET

ENERGY NOTES:

*FENESTRATION U-FACTOR WINDOW AND DOORS TO BE .40 STICKER SHALL REMAIN ON WINDOWS, SKYLIGHTS & DOORS UNTIL INSPECTED AND APPROVED FOR THE ABOVE REQUIREMENT. THE FOUNDATION SLAB INSULATION MAY BE ELIMINATED IF USING A MAX. 0.32 U-FACTOR ON GLAZING.

2. CEILINGS * CEILING INSULATION TO BE MIN. R-30 (ZONE 2); R-38 (ZONE 4) | COMMEN WALLS BETWEEN DWELLING UNITS MARKERS SHALL BE AFFIXED TO THE TRUSSES OR JOIST AND MARKED WITH THE MIN. ISTALLED THICKNESS BY ONE INCH HIGH NUMBERS. A MIN. OF ONE MARKER SHALL BE INSTALLED 6. FENESTRATION AIR LEAKAGE FOR EVERY 300 SQ. FT. OF AREA WITH NUMBERS TO FACE THE ATTIC ACCESS OPENING. MARKERS MUST BE INSTALLED AT ROUGH IN OR WALL INSULATION INSPECTIONS.

WOOD FRAMED EXTERIOR WALLS (MIN. R-19 FOR 2 X 6 WALLS) * WALL INSULATION SHALL BE IN SUBSTANTIAL CONTACT WITH THE SURFACE BEING INSULATED TO AVOID AIR PATHS THAT BYPASS THE INSULATION. * INSULATION SHALL NOT BE COMPRESSED BY INSET STAPLING OF THE BATT INSULATION OR OTHER MEANS * INSULATION SHALL FILL ALL CAVATIES COMPLETLY BY CUTTING INSULATION AROUND ELECTRCAL OUTLETS AND SWITCHES AND BY SLICING INSULATION TO FIT BEHIND AND IN FRONT OF ELECTRICAL WIRING IN THE CAVITY AND PLUMBING PIPING * BAND JOISTS AND OTHER INTERSTITIAL FLOOR ELEMENTS

4. NOT USED.

5. BUILDING THERMAL ENVELOPE

DRAIN

EXTERIOR OF

OF THE WALL SHALL BE INSULATED

THE SEALING METHODS BETWEEN DISSIMILAR MATERAILS SHALL ALLOW FOR DIFFERENTAIL EXPANSION AND CONTRACTION. THE FOLLOWING SHALL BE CAULKED, GASKETED WEATHER STRIPPED OR OTHERWISE SEALED WITH AN AIR BARRIER MATERIAL, SUITABLE FILM OR SOLID MATERIAL:

14. ALL ELECTRICAL FIXTURES SHALL BE LISTED, AND LABELED ('UL' OR OTHER EQUAL TESTING). A. ALL JOINTS, SEAMS AND PENETRATIONS. B. SITE BUILT WINDOWS, DOORS AND SKYLIGHTS OPENINGS BETWEEN WINDO AND DOOR ASSEMBLIES AND THEIR RESPECTIVE JAMBS AND FRAMING.

UTILITY PENETRATIONS. DROPPED CEILINGS OR CHASES ADJACENT TO THE THERMAL ENVELOPE.

F. KNEE WALLS G. WALLS AND CEILINGS SEPERATING GARAGE FROM CONDITIONED SPACES. BEHIND TUB AND SHOWERS ON EXTERIOR WALLS J. OTHER SOURCES OF INFILTRATION.

* WINDOW, SKYLIGHT AND SLIDING GLASS DOOR SHALL HAVE AN AIR INFILTRATION RATE OF NO MORE THAN 0.3 CFM PER SQUARE FOOT, AND SINGING DOORS NO MORE THAN 0.5 CFM. SPECIFICATIONS SHALL BE LISTED ON THE MANUF. LABEL.

(USE TYVEK HOUSE WRAP, INSTALL PER MANUF. SPECS) . RECESSED LIGHTING RECESSED LUMINAIRES INSTALLED IN THE BUILDING THERMAL ENEVELOPE SHALL BE SEALED TO LIMIT AIR LEAKAGE BETWEEN CONDITIONED AND UNCONDITIONED SPACES BY

A. 1C RATED AND LABELED WITH ENCLOSURES THAT ARE SEALED OR GASKETED TO PREVENT AIR LEAKAGE TO CEILING CAVITY OR UNCONDITIONED SPACE; OR B. IC RATED AND LABELED AS MEETING ASTM E 283; OR C. LOCATED INSIDE AIRTIGHT SEALED BOX WITH CLEARANCES 15. EQUIPTMENT SIZING OF AT LEAST 0.5 INCH FROM COMBUSTIBLE MATERIAL AND 3 INCHEDS FROM INSULATION.

8. HEAT PUMP SUPPLEMENTARY HEAT

* HEAT PUMPS HAVING SUPPLEMENTARY ELECTRIC- RESISTANCE HEAT SHALL HAVE CONTROLS THAT, EXCEPT DURING DEFROST PREVENT SUPPLEMENTAL HEAT OPERATION WHTN THE HEAT PUMP COMPRESSOR CAN MEET THE HEATING LOAD.

* AT LEAST ONE THERMOSTAT SHALL BE PROVIDED FOR EACH SEPERATE HEATING & COOLING SYSTEM.

* SUPPLY AND RETURN DUCTS SHALL BE INSULATED TO A MIN. OF R-8 (EXCEPT DUCTS THAT COMPLETLY INSIDE THE BUILDING THERMAL ENVELOPE.

200A ELEC.

SES

* ALL DUCTS, AIR HANDLERS, FILTER BOXES, AND BUILDING CAVITIES (NOT FOR AIR SUPPLY) USED AS DUCTS SHALL BE SEALED. JOINTS AND SEAMS SHALL COMPLY WITH SECTION M1601.3.1 OF THE IRC.

12. MECHANICAL SYSTEM PIPING INSULATION * MECHANICAL SYSTEM PIPING CAPABLE OF CARRYING FLUIDS ABOVE 105 D. F OR BELOW 55 D. F SHALL BE INSULATED TO A MIN. OF R-2

13. CIRCULATING HOT WATER SYSTEMS

WITH SECTION M1401.3 OF THE IRC.

ELECTRICAL GENERAL NOTES

1. ALL WORKMANSHIP, MATERIALS, AND METHODS SHALL CONFORM TO

3. ALL RECEPTICALS IN BATHROOMS, OUTSIDE & WITHIN 6' OF

NEW AUDIBLE SYSTEM INSIDE EXISTING RESIDENCE.

BRANCH CIRCUIT FOR BATHROOM RECEPTACLES.

2. ALL HABITABLE ROOMS SHALL BE PROVIDED W/ ELECTRICAL OUTLETS

SO THAT NO PART OF THE WALL IS MORE THAN 6' FROM AN OUTLET.

WALL SECTIONS 2' OR LARGER & KITCHEN COUNTERS WIDER THAN 12"

4. ALL SMOKE DETECTORS SHALL BE INTERCONNECTED ON SEPARATE

5. LIGHTS IN CLOSETS SHALL BE 18' FROM SHELVING (MEASURED HORZTL.

CIRCUIT & SHALL RECEIVE PRIMARY POWER FROM BUILDING WIRING &

SHALL HAVE BATTERY BACKUP, CONNECT NEW SMOKE DETECTORS TO

6. PROVIDE MINIMUM TWO 20A BRANCH CIRCUITS FOR RECEPTACLES

LOCATED IN THE KITCHEN, PANTRY, EATING AREA, A SEPARATE 2014

BRANCH CIRCUIT TO THE LAUNDRY EQUIP., AND A SEPARATE 20A

7. ALL BRANCH CIRCUITS THAT SUPPLY 120-VOLT SINGLE PHASE 15 & 20 AMP OUTLETS INSTALLED IN FAMILY ROOMS, DINING ROOMS LIVING ROOMS, PARLORS, LIBRARIES, DENS, BEDROOMS, SUNROOMS

8. FIXTURES, FITTINGS, BOXES AND RECEPTACLES LOCATED IN DAMP OR WET LOCATIONS SHALL BE 'LISTED' TO BE SUITABLE FOR

9. CONTRACTOR TO EMBED 20' OF #4 GA. COPPER WIRE IN FOOTING FOR ELECTRICAL SERVICE GROUND. PROVIDE

GROUND PORTION OF GAS PIPING SYSTEM.

BONDING TO THE INTERIOR WATER PIPING AND ABOVE

10. IN KITCHEN AND DINING ROOMS A RECEPTACLE OUTLET SHALL BE INSTALLED AT EACH WALL COUNTER SPACE 12" OR WIDER SO THAT AT NO POINT ALONG THE WALL IS MORE THAN 24" FROM A RECEPTACLE OUTLET AND SHALL BE GFCI PROTECTED.

11. PROVIDE AT LEAST ONE WEATHER PROOF RECEPTACLE OUTLET NOT MORE THAN 6'-6" ABOVE GRADE AND GFCI PROTECTED. AT THE FRONT AND BACK OF EACH DWELLING. ALL RECEPTACLES INSTALLED OUTDOORS MUST BE GFCI PROTECTED.

12. ALL EXTERIOR LIGHTING SHALL CONFORM TO YAVAPAI COUNTY

13. IN ATTICS, A SERVICE OUTLET & LIGHTING FIXTURE LOCATED NEAR THE APPLIANCE REQUIRING SERVICE SHALL BE CONTROLLED BY A SWITCH AT THE ENTRY OF THE ATTIC. (REQUIRED FOR

RECREATION ROOMS, CLOSETS, HALLWAYS AND SIMILAR ROOMS OR AREAS SHALL BE PROTECTED BY COMBINATION TYPE ARC FAULT CIRCUIT INTERUPTERS INTALLED TO PROVIDE PROTECTION OF THE

N.E.C. - 2017 EDITION.

OR BE RECESSED.

BRANCH CIRCUIT.

SUCH CONDITIONS.

DARK SKY ORDINANCE.

ATTIC MOUNT FURNACES)

SHALL BE SERVICED BY A RECEPTACLE.

WATER SOURCE SHALL BE G.F.C.I.


* ALL CIRCULATING SERVICE HOT WATER PIPING SHALL BE INSULATED TO AT LEAST R-2. ALL NEW RESIDENCES WITH 2 OR MORE BATHROOMS SHALL HAVE A CIRCULATING HOT WATER SYSTEM. CHWS SHALL INCLUDE AN AUTOMATIC OR READILY ACCESSIBLE MANUAL SWITCH THAT CAN TURN OFF THE HWCP WHEN THE SYSTEM IS NOT IN USE. THERMAL SIPHONING SYSTEMS SHALL HAVE A VALVE TO REDUCE FLOW. ALTERNATE SYSTEM SHALL BE CONSIDERED.

14. MECHANICAL VENTIALTION *OUTDOOR AIR INTAKES AND EXHAUST SHALL HAVE AUTOMATIC GRAVITY DAMPER THAT CLOSE WHEN THE VENTILATION SYSTEM

*HEATING & COOLING EQUIPTMENT SHALL BE SIZED IN ACCORDANCE

16. AIR LEAKAGE AIR FLOW RETARDERS (HOUSE WRAPS) MUST BE: A. IMPERMEABLE TO AIR FLOW.

B. CONTINOUS OVER THE ENTIRE BUILDING ENVELOPE ABLE TO WITHSTAND THE FORCES THAT MAY ACT ON IT DURING AND AFTER CONSTRUCTION. D. DURABLE OVER THE EXPECTED LIFETIME OF THE BUILDING E. ALL SEAMS AND EDGES MUST BE SEALED/TAPED PER MANUF SPECIFICATIONS

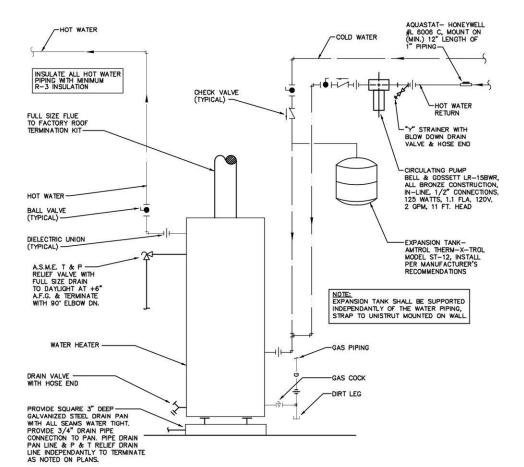

GAS WATER HEATER OPTION

NOTE: INTERIOR GAS LINES TO BE MIN. 1/2" RANGE GAS PIPING ISOMETRIC

GFCI **ELECTRICAL PLAN** SCALE: 1/4" = 1'-0"

PER SECTION 210-12 OF THE 2017 N

ARC-FAULT CIRCUIT

INTERRUPTERS ARE REQUIRED

COMP.

DISC.

SWITCH

A/C COMP. ON

FURNACE TO

PANEL'

HEATER

PROVIDE 12" SQ. COMBUSTION

AIR VENTS, ONE 12" ABOVE-

FLOOR, ONE 12' BELOW

GFCI

TO PANEL

GFCI

INTERCONNECTED SMOKE DETECTORS

ARE REQUIRED FOR THIS PROJECT

PER R314.3.1. EACH SLEEPING ROOM

OUTSIDE EACH SLEEPING ROOM, AND

ON EACH FLOOR LEVEL.

CEILING T. \$ P. F.F.H.B. DRAIN PROVIDE EXPANSION TANK, AND RECIRCULATING SYSTEM FOR HOT WATER COMBUSTION AIR CALC: PROVIDE I SQ. IN. PER 4,000 BTU HTG. FIGURE 26,000 BTU HEATING DIVIDED BY 4000 = 6.5 MIN. SQ. IN. ATTIC RXA ACCESS APPROVAL IS SUBJECT TO FIELD INSPECTION AND COMPLIANCE 415 CFM 415 CFM WITH ALL RELEVANT CODES, LAWS AND ORDINANCES THE MECHANICAL EQUIPMENT, DESIGN AND SYSTEM HAVE BEEN REVIEWED FOR THE BASIC DESIGN **ONLY** THE HVAC CONTRACTOR SHALL REVIEW PLANS/CALCULATIONS TO ASSURE DESIGN S ADEQUATE AND COPMLIES WITH ALL APPLICABLE CODES PRIOR TO INSTALLATION. 570 CFM 570 CFM

F.F.H.B. WATER

PROPERTY OF YAVAPAI COUNTY

EFFECTIVE APRIL 20, 2006

FULLY SHIELDED FIXTURES AR

REQUIRED FOR ALL EXTERIOR LAMP:

HVAC PLAN SCALE: 1/4" = 1'-0"

SUPPLY-AIR GRILL

THERMOSTAT

HVAC GENERAL NOTES:

, THE MECHANICAL CONTRACTOR SHALL DETERMINE THE FINAL EQUIPMENT SIZING, DUCT SIZING, AND DUCT LAYOUT PRIOR TO INSTALLATION. RETURN AIR GRILL 2. DRAIN AND VENT SIZES TO BE DETERMINED BY PLUMBING CONTRACTOR. 3. WATER HEATER RELIEF VALVE SHALL EXTEND OUTSIDE OF THE BUILDING WITH THE END OF THE PIPE NOT MORE THAN 2' NOR LESS THAN 6" ABOVE THE GROUND AND POINTING DOWNWARD.

4. PROVIDE A PAN, AND DRAIN FOR THE WATER HEATER.

5. THE CLOTHES DRYER EXHAUST DUCT SHALL BE AT LEAST THE DIAMETER OF THE APPLIANCE OUTLET AS RECOMMENDED BY THE MANUFACTURER AND SHALL TERMINATE AT THE EXTERIOR OF THE BUILDING. IT SHALL NOT EXCEED 25' IN LENGTH WITH REDUCTIONS FOR BENDS. THE DUCT SHALL TERMINATE NOT LESS THAN 3' FROM A PROPERTY LINE.

Date Drawn by MFR Chk'd by: AS NOTED Scale Revisions: This drawing is the property of Mark Rogers, Architect, PLLC, and is not to be reproduced or copied in whole or in part. It is only to be used or the project and site specifically identified herein and is not to be used on any other project. It is to be returned upon request. Scales as stated hereon are valid on the origina

drawing only. Contractor shall carefully review a dimensions and conditions shown hereon and at once report to the Architect any error, inconsistancy or omission he may discover.



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ARKI

MASTES RIGHT P.

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SCREGO, 2 BATH

出

ARIZ

SYMB(BEDROOM 3

SHEET NO:

ME-1

PROPERTY OF YAVAPAI COUNTY, AZ

REVIEWED FOR DESIGN CRITERIA ONLY

ELECTRIC WATER HEATER DETAIL NO SCALE

+ 4" SPACE

ALL AROUND

EXPANSION TANK (PROVIDE SUPPORT)

— S.O.V., (TYP)

- UNION, TYPE

- T&P FULL-SIZE RELIEF LINE

TO EXTERIOR

GALV. DRAIN PAN (24 GA. MIN.)

- CHECK VALVE TYP.

─ HOT WATER RETURN

NOTE: DRAIN PAN, AND T&P

MUST DRAIN BY GRAVITY. WATER

HEATER SHALL BE HIGH ENOUGH

DISCHARGE PIPING TO EXTERIOR.

OFF THE FLOOR TO PROVIDE FOR NO SCALE

SIZE OF INCOMING WILL BE BASED ON DISTANCE TO GAS SQURCE.