2018 IRC - IBC

2006 **IECC**

CALL TWO WORKING DAYS BEFORE YOU DIG

1-800-STAKE-IT (1-800-782-5348) YAVAPAI COUNTY

2018 IRC R311.3 There shall be a floor or landing on each side of the exterior door. The width of the landing shall not be less than the door served with a minimum distance of 36" measured in the direction traveled.

The inspector may require further clarification on stamped plans. This may include, but not limited to a special inspection and /or a cross section detail stamped and signed by the Designer/Architect/Engineer of record.

YAVAPAI DEVELOPMENT SERVICES

	*PARCEL:
	*OWNER/APPLICANT:
	PERMIT #:
HOME OF MY OWN - 1 RED LEFT (2024 PLANS)	PROJECT:

CAUTION

Yavapai County permitted building plans do not relieve the Owners or General Contractor from their responsibilities to conform to all adopted building codes. Every effort has been made to provide a thorough plan review, however plans may contain irregularities. If plans do not contain the proper information or details the Owner/General Contractor Shall Not proceed with the project until the issue has been resolved through Yavapai County and any professional involved in the project

Per 2018 IRCR309.1, R309.2, and IBC 406.3.3: Garage/ carport surfaces used for parking of vehicles shall be sloped to drain liquids to the main vehicle entry doorway or an approved drain

THE ENGINEERED

GEOTECHNICAL REPORT IS A

PART OF THE PERMITTED

DOCUMENTS, AND SHALL BE

ONSITE AT ALL TIMES WITH THE

PERMITTED PLANS.

Applicant acknowledges that plans stamped by a

registrant will not be fully reviewed by staff and

that approvals are contingent upon favorable

field inspections. Should conditions in the field

prove non-conducive to code requirements,

Effective April 20, 2006, **Fully shielded fixtures are** required for all exterior lamps

The mechanical equipment, design and system have been reviewed for the basic design ONLY. The HVAC contractor shall review the plans/ calculations to assure the design is adequate and complies with all applicable codes and installation

* Information required to be filled out by the applicant.

Yavapai County Ordinance, Section 112.6 **Drainage across Property Lines.**

Drainage across property lines shall not exceed that which existed prior to grading. Excess or concentrated drainage shall be contained on site or directed to an approved drainage facility. Erosion of the ground in the area of discharge shall be prevented by installation of non-erosive down-drains or

other devices.

Per Article 210.12 of the **2017 NEC**

Arc fault circuit interupters are required

A separate permit for alternative

electric source is required. The

alternative electric source

permit will need to be issued

and finalized before a building

final can be obtained

THE GAS PIPING INSTALLER SHALL **VERIFY THE SYSTEM IS OF SUCH SIZE** FOR THE MAXIMUM DEMAND AND TO **MEET EACH APPLIANCE INLET AT NOT** LESS THAN THE MINIMUM SUPPLY PRESSURE REQUIRED

Foam spray shall comply with the ES Reports

and applicable codes. It is the responsibility

of the owner and/or contractor(s) to review

reports and understand requirements before

application. Ignition/thermal barrier is

required unless otherwise exempt. Failure to

comply may cause additional cost to the

owner/contractor(s).

THIRD PARTY SPECIAL INSPECTIONS REQUIRED: (Third party special inspections are not in lieu of required building inspections.) YES

The following items require special inspections:

- SOILS CONDITION
- SOILS COMPACTION
- BOTTOM OF FOOTING COMPACTION
- AND OTHER INSPECTIONS REQUIRED BY THE GEOTECHNICAL ENGINEER.

Reports to be supplied to the Building Inspector

It is imperative that the owner /contractor print ALL permit documents from the online portal before inspection.

CAUTION:

Areas within Yavapai County are likely to have expansive, compressible, shifting or other unknown soils conditions. The building official may require a soils test to determine the soils characteristic at a particular location.

significant delays may be realized. Applicant attests that the sealed plans are in compliance with all applicable codes and ordinances

GENERAL GRADING NOTES: Where the lot line walls, slopes, or other physical barriers prohibit 6" of fall within 10', drains or swales shall be provided to insure drainage away from the structure.

MAINTAIN MINIMUM 2:1 SLOPE The faces of cut and fill slopes shall be prepared and maintained to control against erosion. The protection for the slopes shall be installed as soon as practicable and prior to requesting final approval. NO GRADING WITHIN 2' OF PROPERTY LINES

aps

Contact APS BEFORE you start construction; APS Prescott Office: 928-443-6797; Prescottcontroldesk@apsc.com APS Cottonwood Office: 928-646-8502; Verdecontroldesk@apsc.com

APS Wickenburg Office: 602-371-6200; Wickenburg controldesk@apsc.co

The property owner shall be responsible to verify fire sprinkler requirements with the governing fire district

Provide at least one window or exterior door approved for emergency escape or rescue for every room used for sleeping purposes. 2018 IRC R310.1

IMPORTANT! Footings will not be

Interconnected smoke detectors are required for this project per **2018 IRC R314.3.1. Each sleeping** room, outside each sleeping room and on each floor level.

APPROVAL IS SUBJECT TO FIELD INSPECTION AND COMPLIANCE WITH **ALL RELEVANT CODES,** LAWS AND ORDINANCES

RAIN GUTTERS & DOWNSPOUTS ARE REQUIRED

Positive drainage away from the structure is required. Refer to the geotechnical report for an additional requirements

inspected until the property corners are properly pinned, flagged and easily identifiable to the building inspector.

No slab grade or floor framing

inspections will be conducted

without compaction reports.

Slab insulation shall be approved for the under slab application. Provide an ES Report and manufacturer's specifications if not using the pre-approved products

- 1. Extruded polystyrene insulation Dow square edge (Blue)
- 2. Extruded polystyrene Owen corning Foamular 250 (Pink)

Per 2018 YCABC Ordinance 2014-1 Section 110.3.4: **Pre-slab inspections are required**

Reviewed for Design Criteria Only

/

Truss calculations to be on site at the time of frame inspection

BIG STAMP

BOARD OF SUPERVISORS


CRAIG BROWN, CHAIRMAN - DISTRICT 4 DONNA G. MICHAELS, Ph.D., VICE CHAIR - DISTRICT 3 HARRY B. OBERG, MEMBER - DISTRICT 1

JAMES GREGORY, MEMBER - DISTRICT 2 MARY MALLORY, MEMBER - DISTRICT 5



DEVELOPMENT SERVICES

JEREMY DYE, DIRECTOR MARK LUSSON, ASSISTANT DIRECTOR WARREN COLVIN, CHIEF BUILDING OFFICIAL

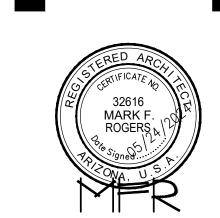

ARIZ

COVER BDRM / S

SHEET NO:

HOME OF MY OWN Phase Two Single-Family Housing ONE BEDROOM / ONE BATH - LEFT PARKING

> YAVAPAI COUNTY, ARIZONA 1015 Fair Street Prescott, Arizona

INDEX TO DRAWINGS

COVER SHEET W/ PROJECT INFORMATION FLOOR PLANS / OPENING SCHEDULES FOUNDATION PLANS ROOF FRAMING PLANS BRACE WALL PLANS EXTERIOR ELEVATIONS A-6.0**BUILDING SECTIONS** A - 7.0**DETAILS MECHANICAL** M-1**ELECTRICAL**

PROJECT INFORMATION

ALL WORK SHALL CONFORM TO ALL YAVAPAI COUNTY ADOPTED CODES, ORDINANCES AND POLICIES, INCLUDING BUT NOT LIMITED TO THE FOLLOWING: 2018 INTERNATIONAL RESIDENTIAL CODE (IRC) 2018 INTERNATIONAL PLUMBING CODE (IPC) 2018 INTERNATIONAL MECHANICAL CODE (IMC) 2017 NATIONAL ELECTRIC CODE (NEC) 2006 INTERNATIONAL ENERGY CONSERVATION CODE (IECC) LIVABLE: 576 SQ. FT. CARPORT/ALT. GARAGE: 257 SQ. FT.

COVERED ENTRY: 96 SQ. FT. **TOTAL UNDER ROOF:** 929 SQ. FT OPTION WITHOUT GARAGE, OR CARPORT LIVABLE: 576 SQ. FT. **COVERED ENTRY:** 96 SQ. FT. **TOTAL UNDER ROOF:** 672 SQ. FT OCCUPANCY: R-3 (Single-Family Residential) CONSTRUCTION TYPE: V-B

THESE HOMES WERE DESIGNED FOR A MAXIMUM ELEVATION OF 6200 FEET (40 LB. SNOW LOAD). THEY WERE NOT DESIGNED FOR A TILE ROOF

GENERAL NOTES

I. DUE TO REPROGRAPHIC PROCESS, THESE PLANS MAY NOT BE ACCURATE TO SCALE, DIMENSIONS ARE NOT TO BE SCALED FROM THE WORKING DRAWINGS.

2. BEFORE ORDERING ANY MATERIALS OR STARTING ANY WORK. CONTRACTORS SHALL VERIFY ALL MEASUREMENTS AND EXISTING CONDITIONS AT THE SITE AND SHALL BE RESPONSIBLE FOR THE CORRECTNESS OF THE SAME. ANY DEVIATION AND/OR UNSAFE OR UNREGULATED CONDITIONS SHALL BE BROUGHT TO THE ATTENTION OF YAVAPAI COUNTY DEVELOPMENT SERVICES.

3. GENERAL CONTRACTOR TO VERIFY AND LOCATE ALL UTILITY STUB OUTS AND MAINS BEFORE BEGINNING CONSTRUCTION OF PROJECT.

4. GENERAL CONTRACTOR TO VERIFY THE REMOVAL AND/OR REPLANTING OF LANDSCAPE IF THE CONDITION OCCURS OVER THE PROJECT SITE.

5. DAMAGE TO SITE, UTILITIES, OR NEWLY BUILT IMPROVEMENTS, NOT DESIGNED FOR REMOVAL, SHALL BE THE RESPONSIBLITY OF THE GENERAL CONTRACTOR INVOLVED, AND SHALL BE REPAIRED OR REPLACED AT THE


6. VERIFY UNIFORMITY OF ALL FRAMING SO AS TO CREATE A SMOOTH, REGULAR FINISH WITH NO IRREGULARITIES.

1. IT IS THE RESPONSIBILTY OF THE GENRAL CONTRACTOR, TO THOROUGHLY REVIEW THE PLANS AND TO NOTIFY YAVAPAI COUNTY DEVELOPMENT SERVICES OF ANY DISCREPANCIES. YAVAPAI COUNTY, NOR THE ARCHITECT-OF-RECORD, WILL NOT BE RESPONSIBLE FOR MATERIALS IMPROPERLY ORDERED OR INSTALLED.

8. FAILURE BY THE GENERAL CONTRACTOR, OR SUB-CONTRACTORS, TO AQUAINT THEM-SELVES WITH ALL AVAILABLE INFORMATION CONCERNING THIS PROJECT SHALL NOT RELIEVE THEM OF THE RESPONSIBILITY TO PERFORM THEIR

9. APPROVAL OF ALL CONSTRUCTION IS SUBJECT TO FIELD VERIFICATION BY YAVAPAI COUNTY PERSONELL.

10. EVERY SLEEPING ROOM SHALL HAVE AT LEAST ONE (1) OPERATING WINDOW, OR DOOR, FOR EMERGENCY EGRESS, OPEN DIRECTLY TO A STREET, ALLEY, OR YARD.

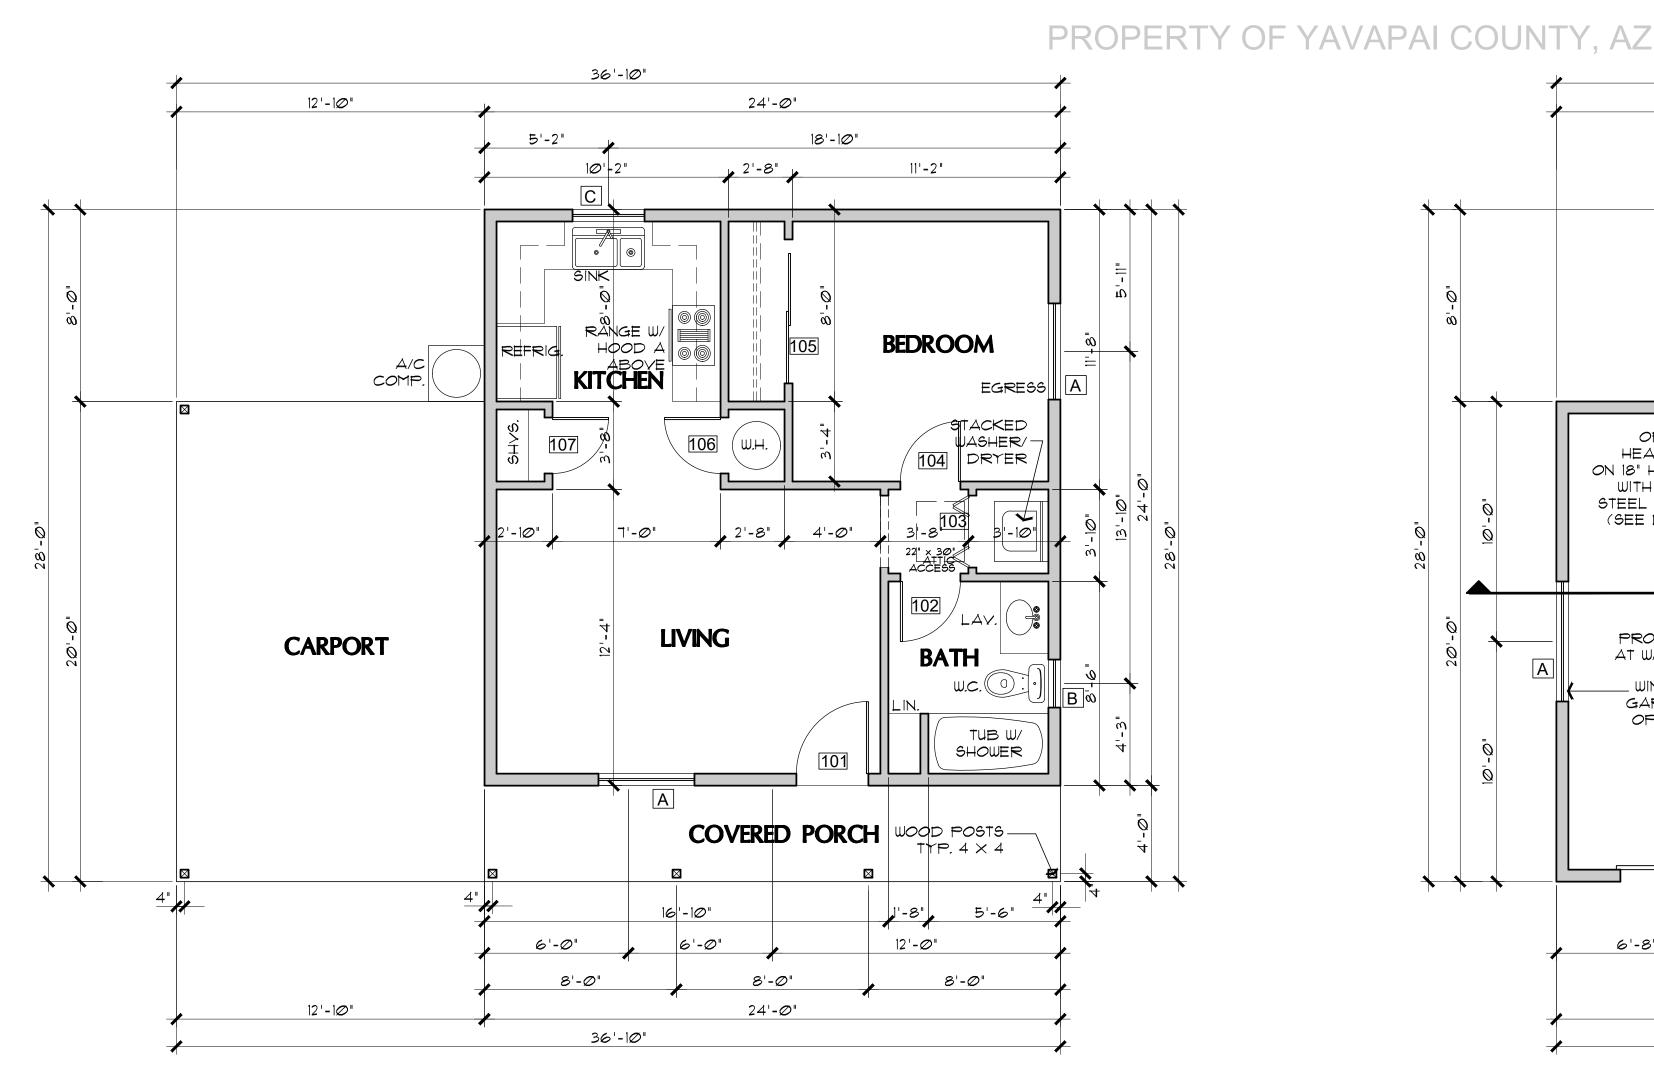

FLOOR PLAN (with Garage option) SCALE: 1/4" = 1'-0"

6'-8"

DOOR SCHEDULE

36'-10"

5'-6"

7'-10"

36'-10"

RANGE W/

KITCHEN

HOOD A

LIVING

COVERED PORCH

7'-8"

23'-6"

24'-Ø"

11'-2"

BEDROOM

104 DRYER

TUB W/

SHOWER

WOOD POSTS -TYP. 4 × 4

8'-Ø"

12'-0"

EGRESS A

12'-10"

OPTIONAL WATER HEATER LOCATION-

GARAGE PROVIDE 1/2" GYP. BD. AT WALLS AND CEILING

13'-4"

WINDOW IN GARAGE IS OPTIONAL.

ON 18" HIGH PLATFORM, WITH MINIMUM 2" DIA. STEEL PIPE BOLLARD (SEE DTL. SHT. A-2.0)

DR.	SIZE			DOOR TYPE	
#	W.	H.	T.		REMARKS
101	3'-0"	6'-8"	1-3/4"	SOLID-CORE WOOD	
102	2'-6"	6'-8"	1-3/8"	INTERIOR HOLLOW CORE	
103	3'-0"	6'-8"	1-1/8"	INTERIOR BI-FOLD	
104	2'-8"	6'-8"	1-3/8"	INTERIOR HOLLOW CORE	
105	6-0"	6'-8"	1-3/8"	SLIDING BI-PASS	
106	2'-4"	6'-8"	1-3/8"	INTERIOR HOLLOW CORE	IF USING GAS WATER HEATER, PROVIDE 12" X 12" VENTS, ONE AT THE TOP, AND BOTTOM OF DOOR
107	2'-6"	6'-8"	1-3/8"	INTERIOR HOLLOW CORE	
108	3'-0"	6'-8"	1-3/4"	SOLID-CORE WOOD	
109	8'-0"	7'-0"	-	OVERHEAD GARAGE DOOR	


WINDOW SCHEDULE (8' plate height)

			<u> </u>
WIN	N. I		
VVII	SIZE	TYPE	REMARKS
Α	4040	ХО	EGRESS AT BEDROOM
В	2030	SINGLE HUNG TEMPERED	
С	3030	XO	

WINDOW SCHEDULE (9' plate height)

	771112	OTT BOILD OLL (o place fieldite
WIN.			DEMARKO
	SIZE	TYPE	REMARKS
Α	4050	XO	EGRESS AT BEDROOM MUST HAVE MAX. 44" SILL HEIGHT ABOVE FLOOR
В	2030	SINGLE HUNG TEMPERED	
С	3030	XO	

FLOOR PLAN (with Carport option) SCALE: 1/4" = 1'-0"

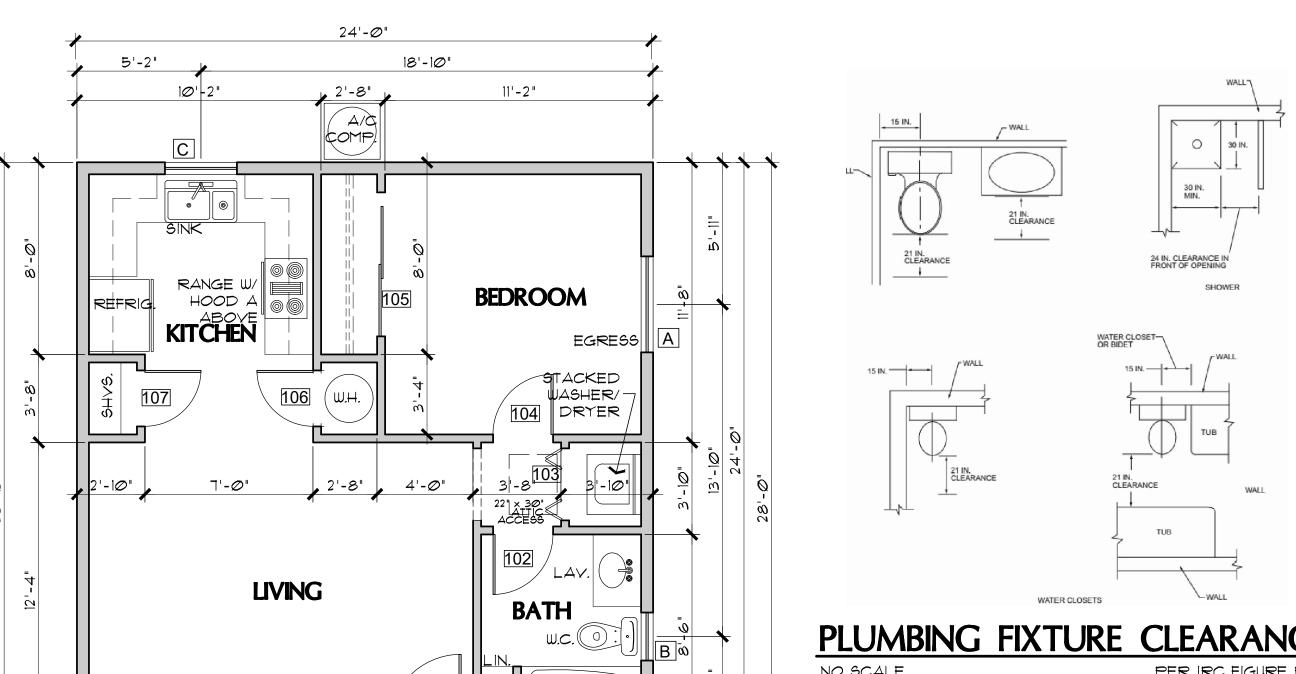

TUB W/ SHOWER

5'-6"

TYP. 4 × 4 ____ WOOD POSTS

12'-0"

PLUMBING FIXTURE CLEARANCES PER IRC FIGURE R3Ø1.1

WINDOWS SHALL BE VINYL FRAME MAX. U-FACTOR: 0.40
(OPTION TO ELIMINATE FOUNDATION INSULATION IF USING 0.32 OR BELOW U-FACTOR)

NOTE: FENESTRATION IN ZONE 2 (ELEVATIONS BELOW 3500 FT.) SHALL HAVE A MAXIMUM U-FACTOR OF 0.75, AND A MAXIMUM FENESTRATION SHGC FACTOR OF 0.40. FENESTRATION IN ZONE 4 (ELEVATIONS 3500 FT. AND ABOVE) SHALL HAVE A MAXIMUM U-FACTOR OF 0.40. THE SHGC FACTOR IN ZONE 4 IS NOT APPLICABLE.

FLOOR PLAN (without Garage or Carport) SCALE: 1/4" = 1'-0"

COVERED PORCH

24'-Ø"

PROPERTY OF YAVAPAI COUNTY. AZ


Drawn by Chk'd by: MFR Scale : AS NOTED Revisions:

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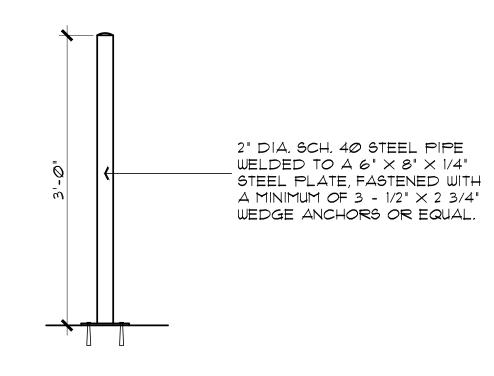
SHEET NO:

A-1.0



FOUNDATION PLAN

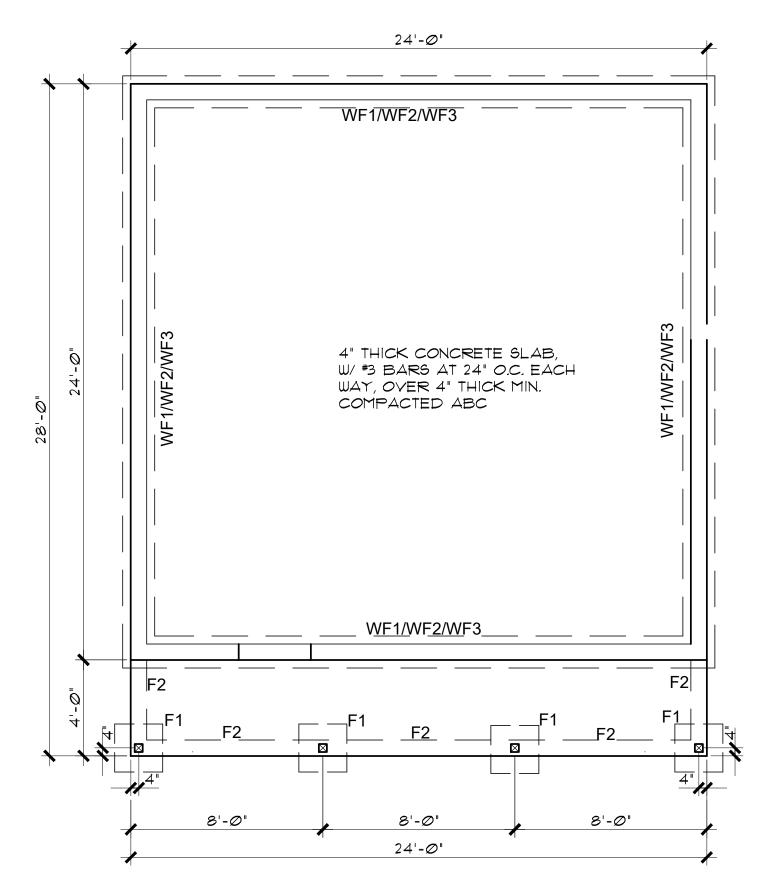SCALE: 1/4" = 1'-0" (without Garage or Carport option)



BOLLARD DETAIL

SCALE: 1" = 1'-0"

THIS DETAIL APPLIES ONLY IF LOCATING
THE WATER HEATER IN THE GARAGE.

NOTE: THE FOOTINGS SIZE, THICKNESS, AND BOTTOM OF FOOTING DEPTH SHALL BE PER THE GEOTECHNICAL REPORT/ENGINEER'S REQUIREMENTS. THIS SHALL INCLUDE ANY OVER EXCAVATIONS, ENGINEERED PAD REQUIREMENTS, AND/OR A CHANGE IN DEPTH, AND TYPE OF BASE COURSE UNDER THE CONCRETE SLABS.


SEE FOUNDATION DETAILS SHEET A7.0

FOUNDATION NOTES


FOOTINGS TO BE A MIN. OF 8" THICK IN 18" MIN. UNDISTURBED SOIL.

- 2. FOOTINGS AND INTERIOR FLATWORK TO BE MIN. 2500 P.S.I. MIN COMPRESSIVE STRENGTH AT 28 DAYS.
- 3. FOUNDATION SUPPORTED WOOD TO EXTEND MIN. 6" ABOVE FINISH GRADE
- 4. FOUNDATION PLATES AND SILLS SHALL BE BOLTED TO FOUNDATION WITH MIN. 1/2" BOLTS 6'-0" O.C., 12" FROM
- CORNERS AND EMBEDDED 7" INTO FOUNDATION WALL 5. EXTERIOR FLATWORK SLOPE TO BE 1/4" PER FOOT.
- 6. CONTRACTOR TO EMBED 20' OF #4 G.A. COPPER WIRE IN FOOTING FOR ELECTRICAL SERVICE GROUND.
- 7. THE GRADE AWAY FROM FOUNDATION WALLS SHALL FALL
- A MINIMUM OF 6 INCHES WITHIN THE FIRST 10 FEET.

 8. ALL EXTERIOR PLATES, LOAD BEARING AND NON LOAD BEARING
- SHALL BE PRESSURE TREATED, LESS THAN 8" ABOVE GRADE
- 9. FILL BEING PLACED THAT EXCEEDS 2' WILL REQUIRE A CERTIFIED COMPACTION TEST AND REPORT.

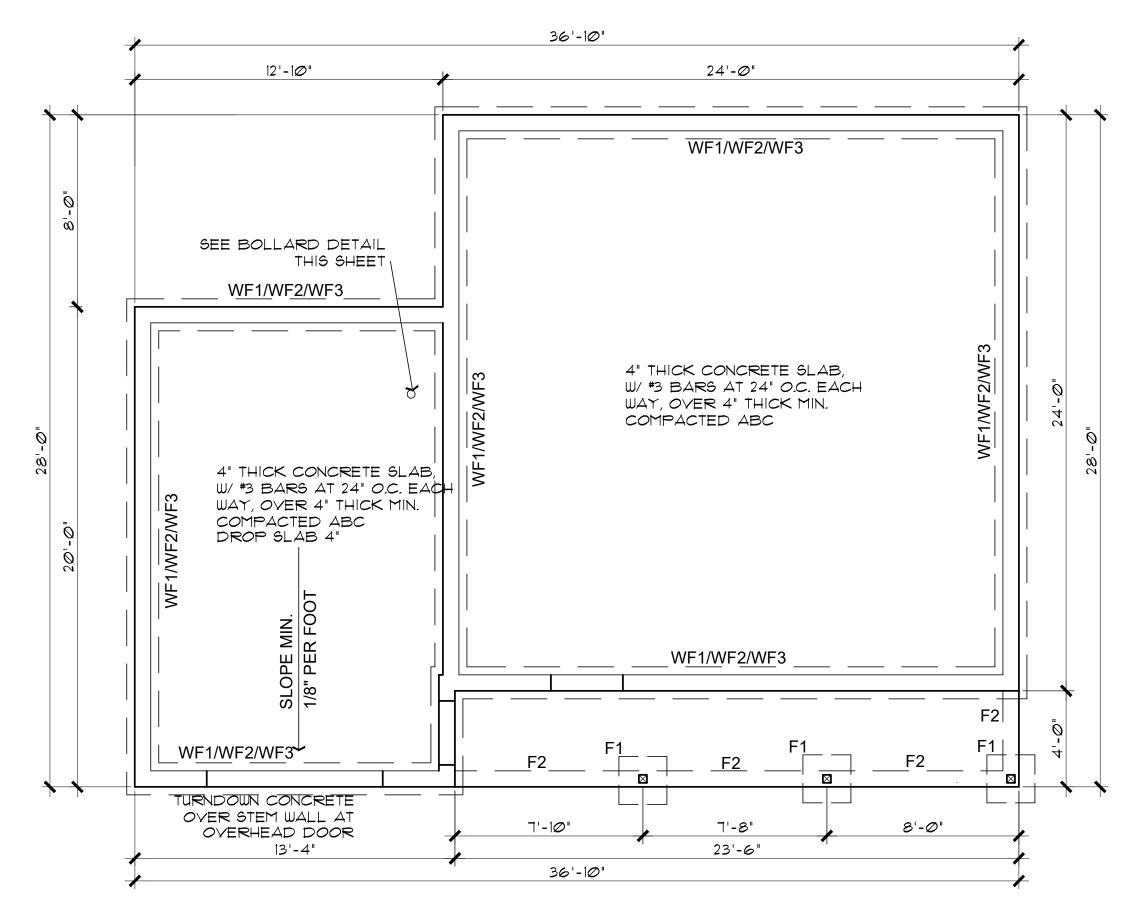

FOUNDATION PLAN (with Garage option)

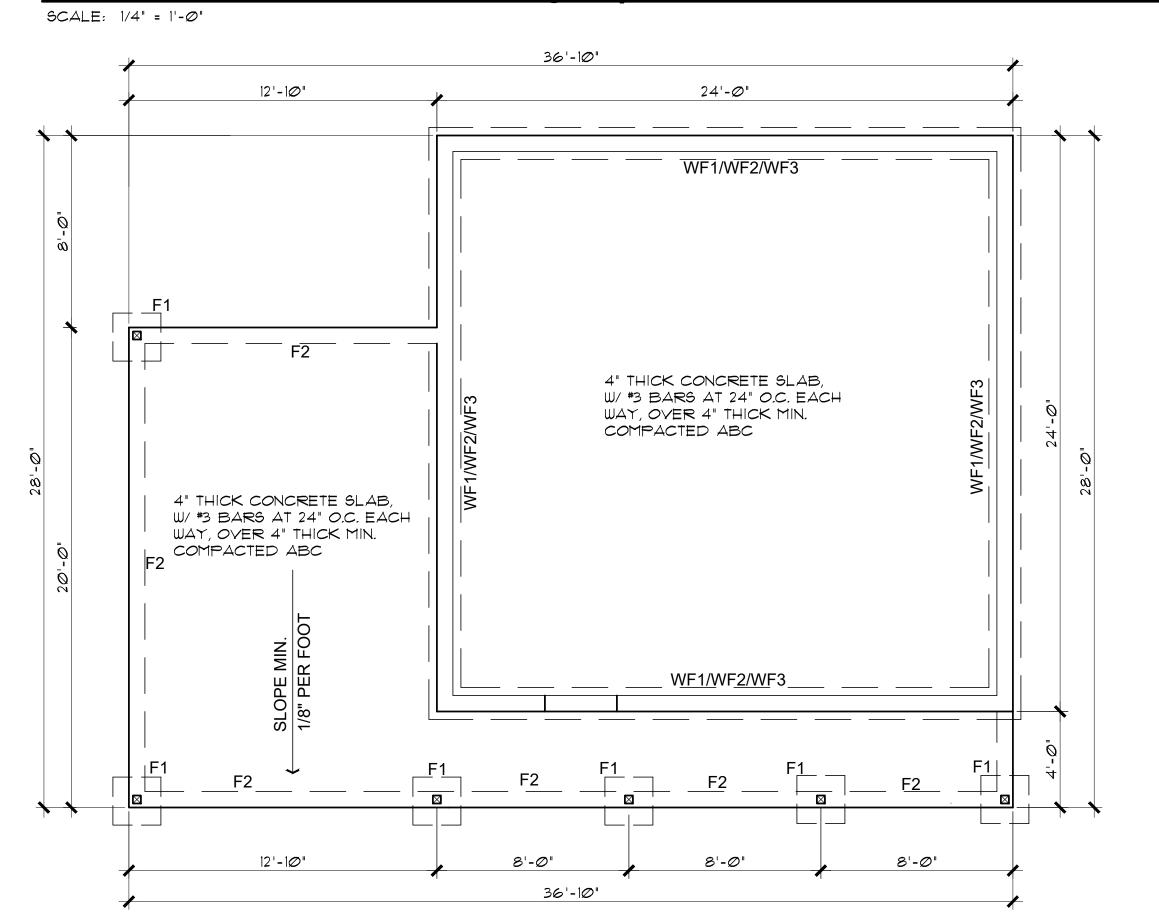

FOUNDATION PLAN (with Carport option)

SCALE: 1/4" = 1'-0"

Maik nogers, Architect, FL

Drawn by:

Scale Revisions:

Chk'd by : MFR

: AS NOTED

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MARK F.


ROGERS N

It is to be returned upon request.

PAI COUNTY, ARIZONA


SHEET NO:

A-2.0

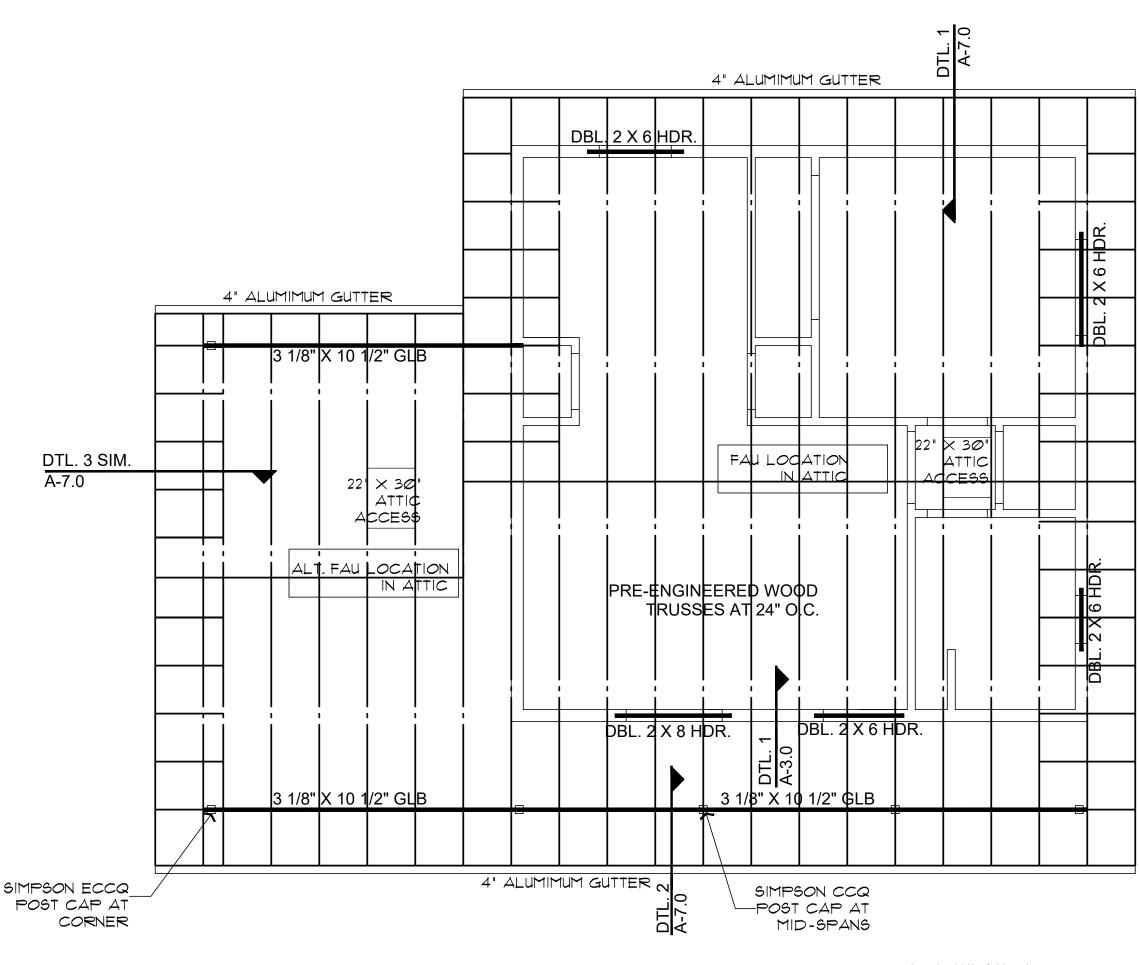

ROOF FRAMING PLAN (with Carport option)

ROOF VENTILATION REQUIRED 929 SQ. FT. / 300 = 3 SQ. FT. (432 SQ. IN.) - USE 2 GABLE-END VENTS AT 144 SQ. IN. MINIMUM EACH VENT SCALE: 1/4" = 1'-0" 288 SQ. IN. AT GABLE ENDS REMAINING LOW VENTING IN BIRDBLOCKS, 3-HOLE, 2" DIA.

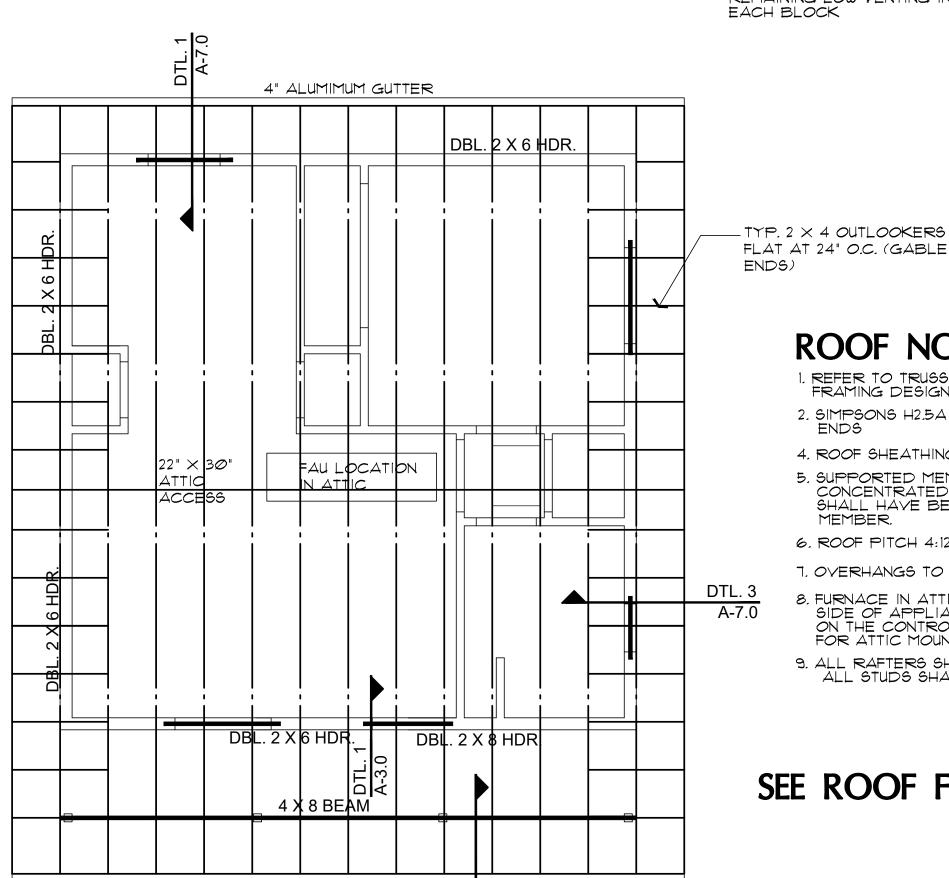

ROOF NOTES

1. REFER TO TRUSS CALCULATIONS FOR FINAL ROOF FRAMING DESIGN.

2. SIMPSONS H2.5A HANGERS TO BE APPLIED @ ALL TRUSS

4. ROOF SHEATHING TO BE 1/2" CDX PLYWOOD, OR OSB.

5. SUPPORTED MEMBERS OF G.L.B. & GIRDERS OR OTHER CONCENTRATED LOADS SUPPORTED BY WALL OR PIER SHALL HAVE BEARING AT LEAST AS WIDE AS THE ROOF

6. ROOF PITCH 4:12 (TYP.).

7. OVERHANGS TO BE 24".

8. FURNACE IN ATTIC: PROVIDE A 24" SOLID PASSAGEWAY TO CONTROL SIDE OF APPLIANCE AND A 30" SERVICE SPACE ON THE CONTROL SIDE OF THE APPLIANCE (REQUIRED FOR ATTIC MOUNT FURNACES)

9. ALL RAFTERS SHALL BE DOUGLAS FIR #2 (SIZE PER PLAN) ALL STUDS SHALL BE HEM FIR #2 (SIZE PER PLAN)


SEE ROOF FRAMING DETAILS SHEET A7.0

ROOF FRAMING PLAN (no Garage or Carport)

ROOF VENTILATION REQUIRED 672 SQ. FT. / 300 = 2.24 (USE 3 SQ. FT.) (432 SQ. IN.)

4" ALUMIMUM GUTTER

USE 2 GABLE-END YENTS AT 144 SQ. IN. MINIMUM EACH YENT 288 SQ. IN. AT GABLE ENDS REMAINING LOW VENTING IN BIRDBLOCKS, 3-HOLE, 2" DIA.

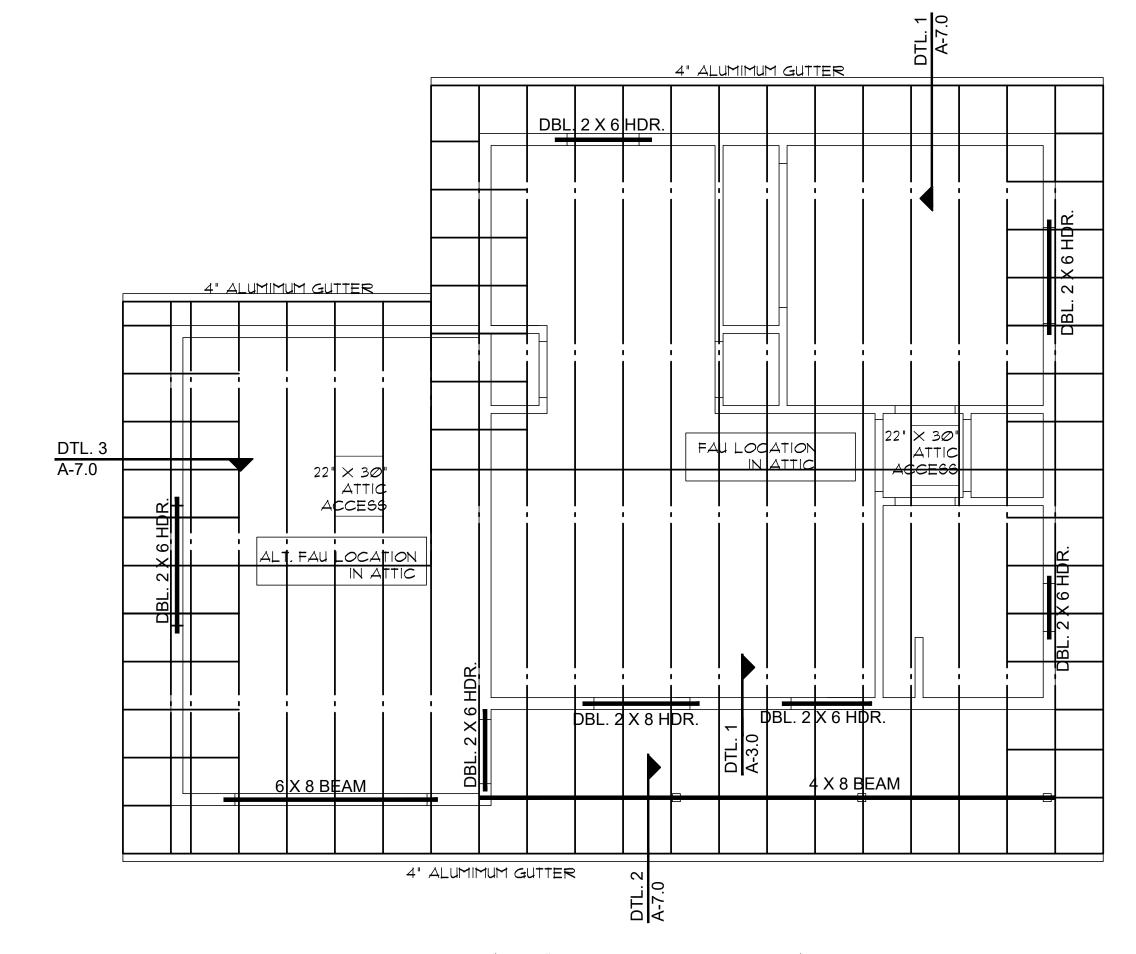


ROOF FRAMING PLAN (with Garage option)

SCALE: 1/4" = 1'-0" ROOF VENTILATION REQUIRED 929 SQ. FT. / 300 = 3 SQ. FT. (432 SQ. IN.) USE 2 GABLE-END VENTS AT 144 SQ. IN. MINIMUM EACH VENT 288 SQ. IN. AT GABLE ENDS REMAINING LOW VENTING IN BIRDBLOCKS, 3-HOLE, 2" DIA.

EACH BLOCK

NOTE: PROVIDE PANEL EDGE SUPPORT FOR NARROW-WIDTH ROOF SHEATHING PER APA TECHNICAL REPORT #R275A.

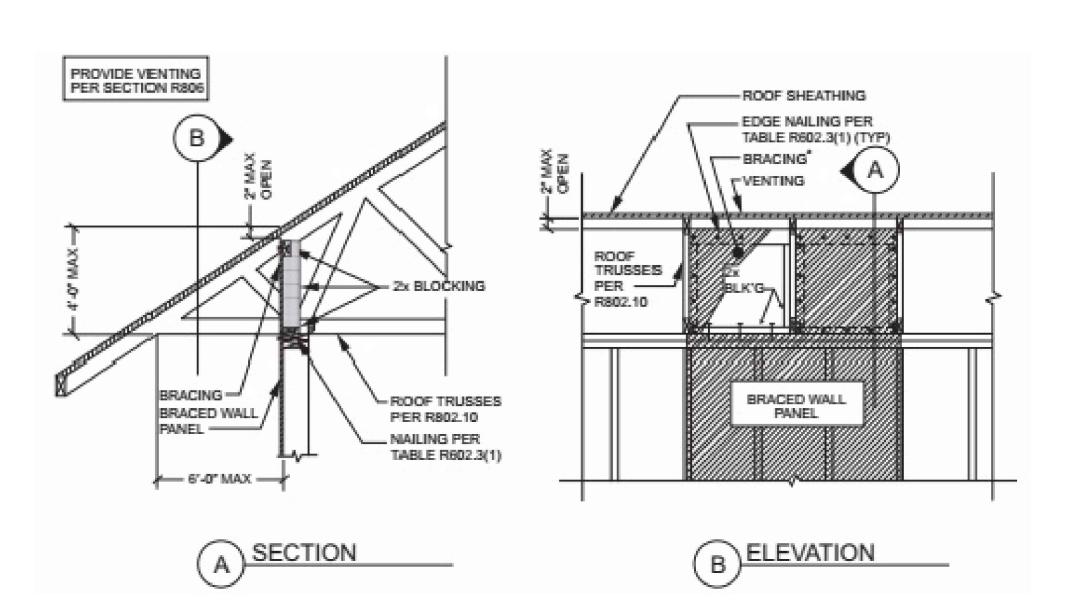

BRACED WALL PANEL CONNECTION OPTION AT PERPENDICULAR ROOF TRUSSES

2018 IRC FIGURE R602.10.8.2(3)

P

MAY 24, 2024

: AS NOTED

MFR

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> MARK F ROGERS N

Drawn by:

Scale Revisions:


Chk'd by: MFR

: FRAMING PLANS BDRM / 1 BATH - LEFT PARKING

SHEET NO:

A - 3.0

\SE

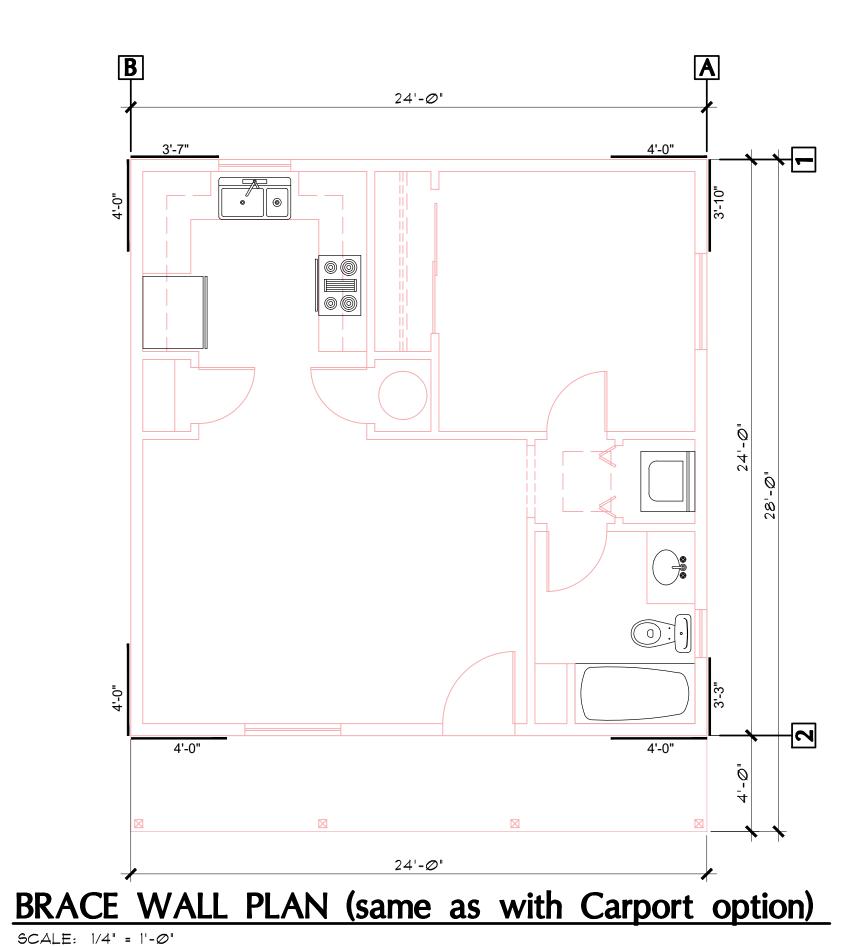

OPTIONS FOR EXTERIOR SIDING-5/8" THICK T1-11, SIDING, 12" MINIMUM GROOVE SPACING. THE T1-11 MAY SERVE AS THE BRACE WALL PANELS, PROVIDED THE CODE REQUIRED NAILING PATTERN IS APPLIED. SEE DETAIL #1, A-6.0 OPTION #2: MINIMUM 3/8" THICK "LP SMART SIDING". (SEE DTL. #1, A-6.0) OPTION #3: STUCCO OVER WEATHER BARRIER, OVER 1/2" PLYWOOD SEE DETAIL #2, A-6.0)

OPTION #4: HORIZ. SIDING OVER WEATHER BARRIER, OVER 1/2" PLYWOOD SEE DETAIL #3, A-6.0)

36'-10" 24'-Ø" 12'-10" 4'-0" 4'-0" 23'-6" 13'-4" FLOÓR PLAN (with Garage option)

BRACE WALL CALCS W/O GARAGE

			DKAC	E VVA		ALCS V	V/U	GAKA	UE					
	WIND SPEED (MPH)	•		115		115		115		115		115		
	BRACED WALL LINE			1		2		Α		В				
STORY		(<mark>X</mark>		(X)		(X								
BR	BRACED WALL PANEL METHOD		CS-WSF	CS-PF CS-G	CS-WSF	CS-PF CS-G	CS-WSF	CS-PF CS-G	CS-WSF	PICS-PFICS-G				
	AVG BWL SPACING (ft)			24		24		24	24		24			
	TABULAR REQUIRED (ft)		;	3.90		3.90	•	3.90	3.90		3.90			
	EXPOSURE		С	1.20	С	1.20	С	1.20	С	1.20	С			
	EAVE-RIDGE HT (ft)		5.00	0.70	5.00	0.70	5.00	0.70	5.00	0.70				
높	STORY HEIGHT (ft)		9.00	0.95	9.00	0.95	9.00	0.95	9.00	0.95				
ADJUSTMENT	# BWLs		2.00	1.00	2.00	1.00	2.00	1.00	2.00	1.00				
ğ	ADD PAIR 800# HOLD DO	WNS	NO	1.00	NO	1.00	NO	1.00	NO	1.00				
₹	OMIT INTERIOR GB	OMIT INTERIOR GB		1.00	NO	1.00	NO	1.00	NO	1.00				
	METHOD GB FASTEN @ 4" o.c		NO	1.00	ИО	1.00	NO	1.00	NO	1.00				
	HORIZONTAL BLOCKING OMITTE		NO	1.00	NO	1.00	NO	1.00	NO	1.00				
REQUIRED BWP LENGTH (ft)			;	3.11	3.11		3.11		3.11					
		BWP	METHOD	LENGTH (ft)	METHOD `	LENGTH (ft)	METHOD	LENGTH (ft)	METHOD	LENGTH (ft)	METHOD	LENGTH (ft)		
		1	CS-WSP	4.00	CS-WSP	4.00	CS-WSP	3.83	CS-WSP	4.00				
BWB		2	CS-WSP	3.58	CS-WSP	4.00	CS-WSP	3.25	CS-WSP	4.00				
뒫	CONTRIBUTING LENGTH	3												
ACTUAL		4												
₹		5												
		6												
		7												
	ACTUAL BWP LENGTH (ft)			7.58		8.00		7.08	8.00					
	ACTUAL ≥ REQUIRED			YES	YES		YES		YES					
SPACE	BWPs ≤ 20' APART		`	YES	,	YES	YES		YES					
# of	Length of BWL (ft)			24	24		24		24					
BWPs	BWP 1 ≤ 16', 2 > 16'			/ES		YES		YES	YES					
ENDS	BWP WITHIN 10' OF EN	ID	YES	YES	YES	YES	YES	YES	YES	YES				
	CONTINUOUS END COND	пои `	3	1	3	3	1	1	3	3				
B	WL COMPLIANCE PASS-FA	L	P	ASS	F	PASS	F	ASS	F	PASS				

V	VIND SPEED (MPH)		115		115		115		115		115	
BRACED WALL LINE			1	2		Α		В				
STORY			â							<u></u>		
BRACE	WALL PANEL METHO	D	CS-WSF	CS-PF CS-G	CS-WSP CS-PF CS-G		CS-WSP CS-PF CS-G		CS-WSP CS-PF CS-G			
AV	G BWL SPACING (ft)		24		24		36.83		36.83			
TAB	ULAR REQUIRED (ft)			3.90	,	3.90	5.52			5.52		
	EXPOSURE		С	1.20	С	1.20	С	1.20	С	1.20	С	
	EAVE-RIDGE HT (ft)		5.00	0.70	5.00	0.70	5.00	0.70	5.00	0.70		
E _	STORY HEIGHT (ft)		9.00	0.95	9.00	0.95	9.00	0.95	9.00	0.95		
ADJUSTMENT	# BWLs		2.00	1.00	2.00	1.00	2.00	1.00	2.00	1.00		
ğ AD	ADD PAIR 800# HOLD DOWNS		NO	1.00	NO	1.00	NO	1.00	NO	1.00		
₹	OMIT INTERIOR GB		NO	1.00	NO	1.00	NO	1.00	NO	1.00		
ME	METHOD GB FASTEN @ 4" o.c		NO	1.00	NO	1.00	NO	1.00	NO	1.00		
HOR	HORIZONTAL BLOCKING OMITTED		NO	1.00	NO	1.00	NO	1.00	NO	1.00		
REQU	IRED BWP LENGTH (ft)		;	3.11		3.11		4.41		4.41		
		BWP	METHOD	LENGTH (ft)	METHOD	LENGTH (ft)	METHOD	LENGTH (ft)	METHOD	LENGTH (ft)	METHOD	LENGTH (ft)
		1	CS-WSP	4.00	CS-WSP	4.00	CS-WSP	3.83	CS-WSP	4.00		
BWP		2	CS-WSP	3.58	CS-WSP	4.00	CS-WSP	3.25	CS-WSP	4.00		
4 CO	NTRIBUTING LENGTH	3	CS-WSP	4.00	CS-WSP	2.67						
ACTUAL COI	NINDOTINO ELINOTI	4										
¥		5										
		6										
		7										
ACTL	JAL BWP LENGTH (ft)		1	1.58	1	0.67	7.08		8.00			
ACTUAL ≥ REQUIRED			,	/ES	YES		YES		YES			
SPACE BWPs ≤ 20' APART			,	/ES	,	YES	,	YES	YES			
# of	Length of BWL (ft)		36.83		3	36.83		24	20			
BWPs	BWP 1 ≤ 16', 2 > 16'		,	/ES	,	YES	,	YES	YES			
ENDS -	BWP WITHIN 10' OF EN	ID	YES	YES	YES	YES	YES	YES	YES	YES		
	NTINUOUS END CONDI	TION	3	3								
DWILL O	OMPLIANCE PASS-FAI	i		ASS		PASS		PASS	I : [PASS		

Mar

Date : MAY 24, 2024

Drawn by: MFR

Chk'd by: MFR

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ROGERS

Scale

Revisions:

- ASHPALT SHINGLES OR METAL ROOFING

+8'-1" OR 9'-1"

+8'-1" OR 9'-1" TOP OF PLATE

TOP OF SLAB

OWNER'S/CONTRACTOR'S OPTION TO PROVIDE WINDOW


AT GARAGE

PAINTED 2×4 TRIM

AROUND ALL OPENINGS AND OUTSIDE CORNERS

SHEET NO:


A - 5.0

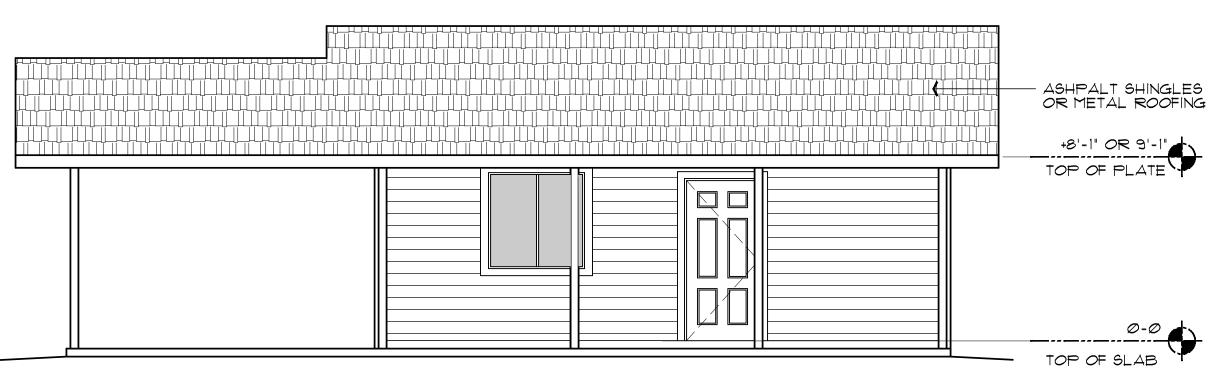



FRONT ELEVATION (with optional Carport)

FRONT ELEVATION (with optional Garage)

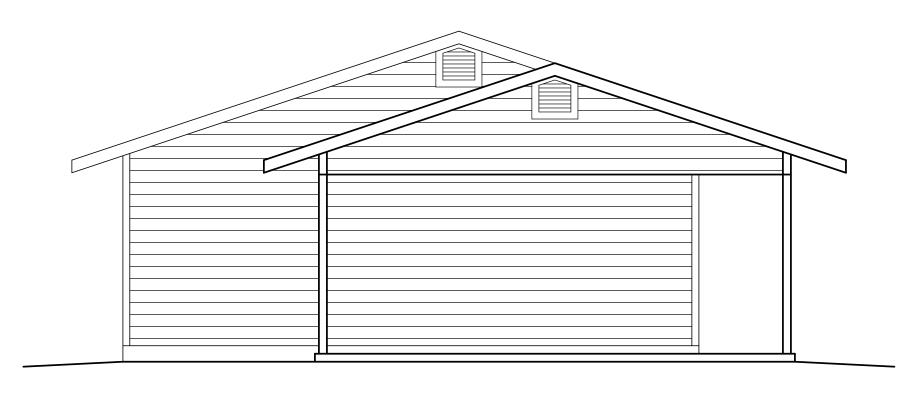


NOTE: SEE SHEET A-4.0 FOR EXTERIOR WALL FINISH OPTIONS.

SCALE: 1/4" = 1'-0"

LEFT SIDE ELEVATION (with optional Carport)


SCALE: 1/4" = 1'-0"

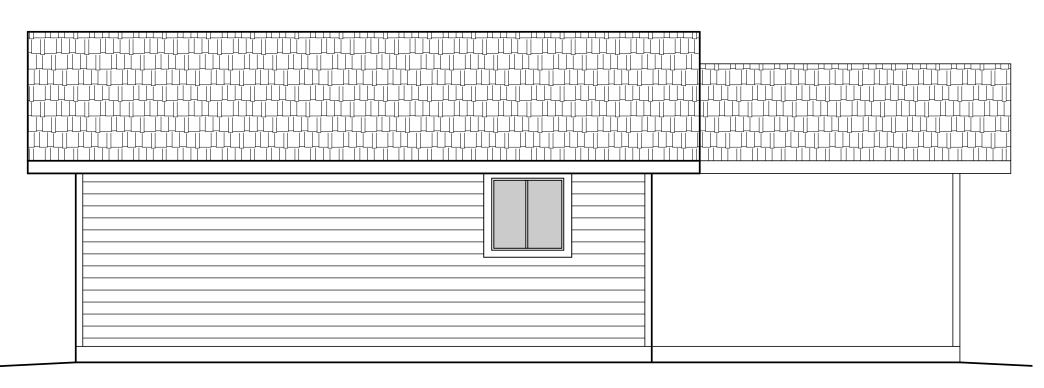

REAR ELEVATION (with optional Carport) SCALE: 1/4" = 1'-0"


FRONT ELEVATION (without Garage, or Carport option)

SCALE: 1/4" = 1'-0"

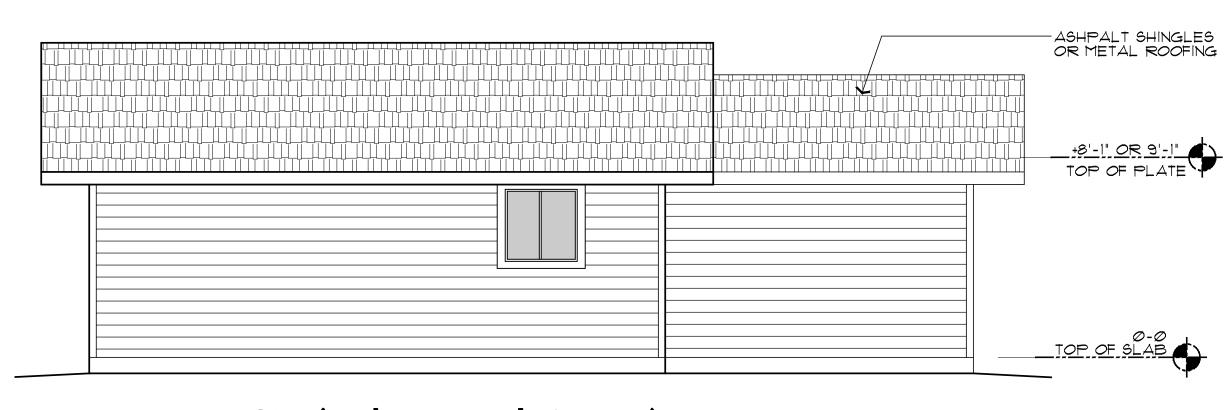


REAR ELEVATION (with optional Garage)

LEFT SIDE ELEVATION (with optional Garage)

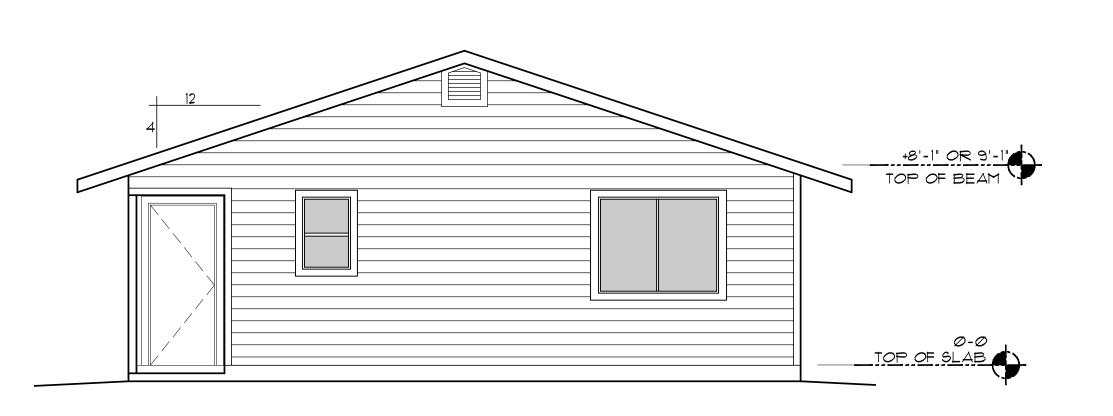



RIGHT SIDE ELEVATION (similar for all options)

SCALE: 1/4" = 1'-0"

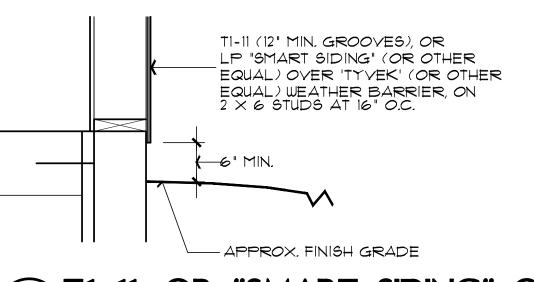


1 T1-11, OR "SMART SIDING" OPTIONS DETAIL

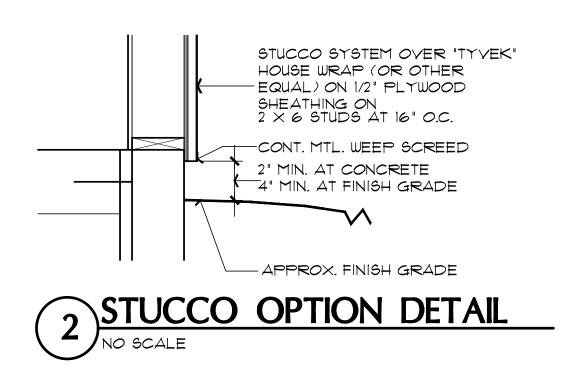


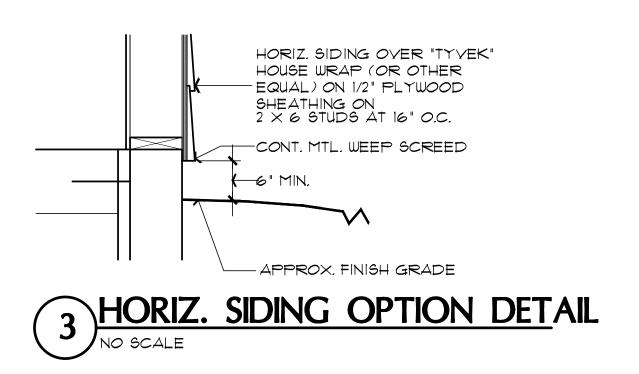


PROPERTY OF YAVAPAI COUNTY, AZ

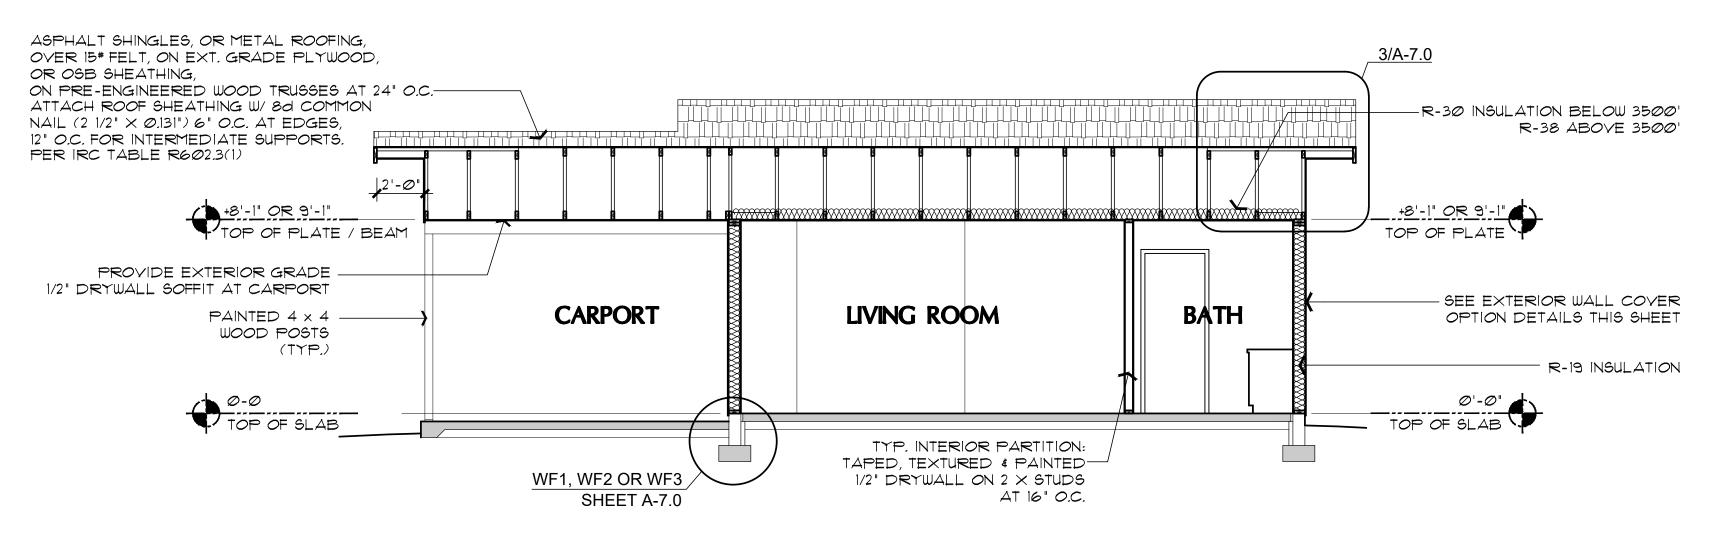

BUILDING CROSS SECTION (with optional Carport) SCALE: 1/4" = 1'-0"

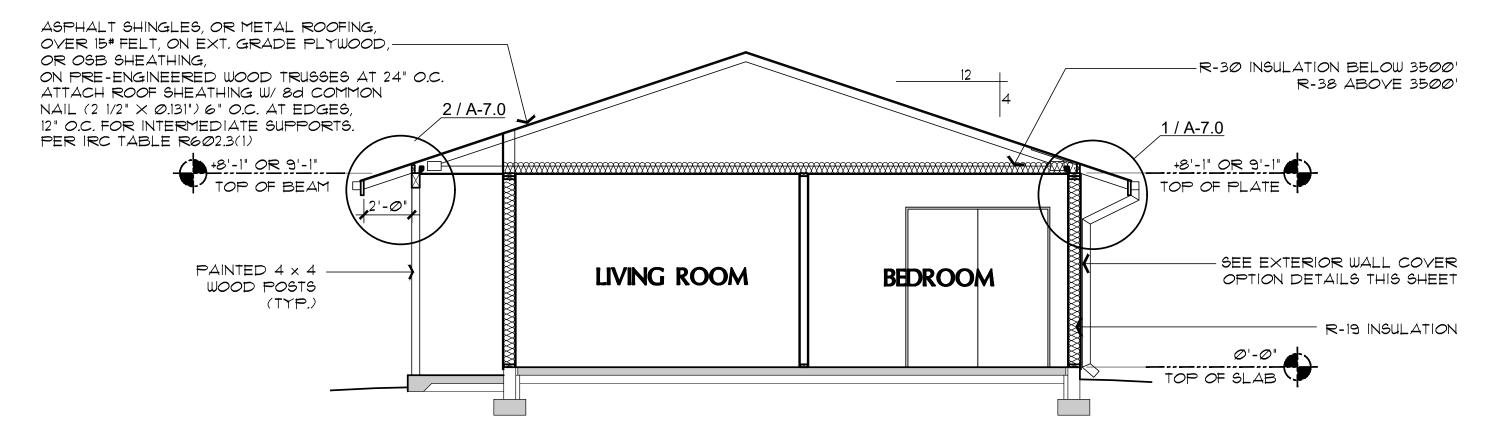

BUILDING CROSS SECTION SCALE: 1/4" = 1'-0"

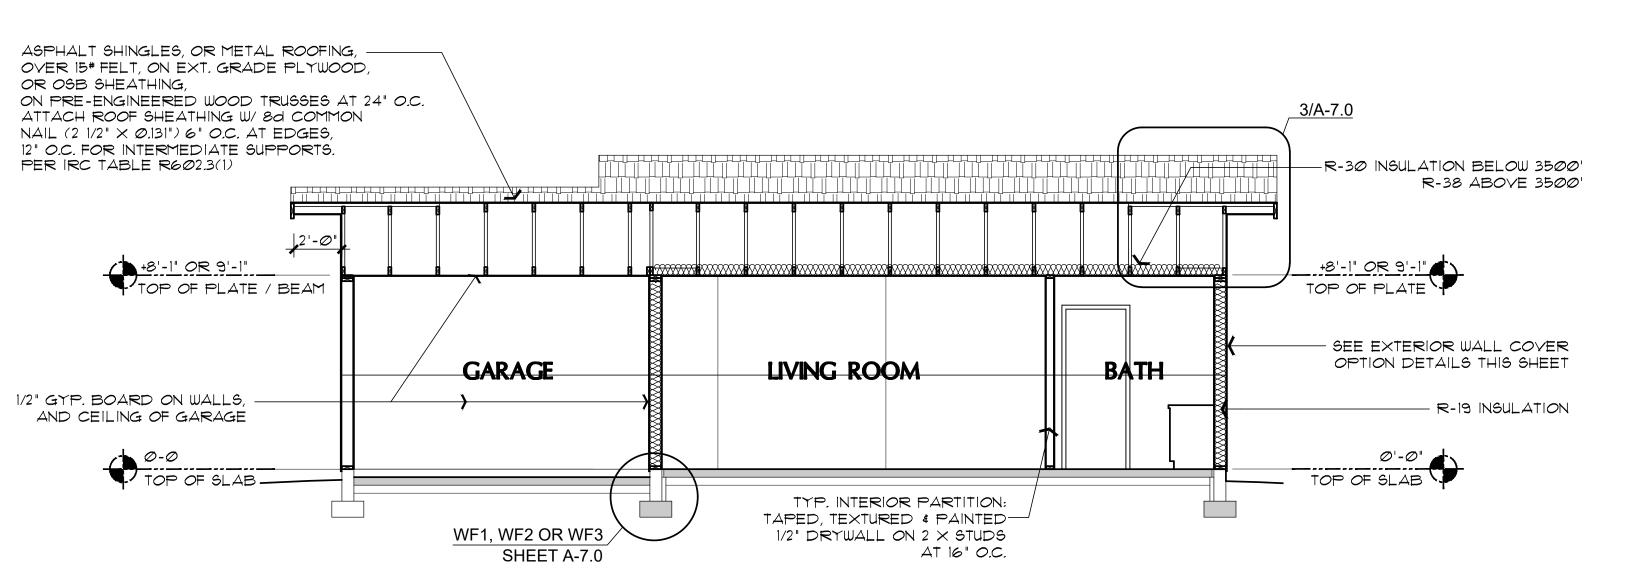

BUILDING CROSS SECTION (with optional Garage) SCALE: 1/4" = 1'-0"

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SECTIONS / 1 BATH - LEFT PARKING

: 1BM/1BA LEFT

: AS NOTED

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Drawn by

Revisions:

Scale

Chk'd by : MFR

MAY <u>24, 2024</u>

ARIZON

A X

PHASE TWO - 1 BDRM SHEET NO:

A - 6.0

POST BASE FOOTING

4" THK. CONC. SLAB W/

TYPICAL TURN-DOWN FOOTING

4" COMP. ABC

#3 BARS AT 32" O.C. EA. WAY OVER

TAPED, TEXTURED & PAINTED 1/2" DRYWALL AT WALLS AND CEILINGS

ASPHALT SHINGLES, OR METAL

INSULATION BAFFLE BETWEEN

-2 imes FRIEZE BOARD (TYPICAL

-CONT. 4" ALUMINUM GUTTER

4" ALUMINUM DOWNSPOUTS AS SHOWN ON ROOF PLAN

R-21 BATT INSULATION

SEE BRACE WALL PLAN SHEET

ASPHALT SHINGLES, OR METAL

ROOF PANELS, OVER 15# MIN. ROOFING

FELT, 1/2" OR 5/8" PLYWOOD SHEATHING,

FOR EXTERIOR WALL FINISH OPTIONS,

OVER WEATHERPROOF MOISTURE/AIR

BARRIER, ON 2 X 6 STUDS AT 16" O.C.

 $-CONT. 2 \times 8 PAINTED FASCIA$

BETWEEN EACH TRUSS). PROVIDE HOLE VENTS W/ INSECT SCREENS

R-38 BATT INSULATION

SIMPSON H2.5A (TYPICAL

EACH TRUSS, UNLESS

NOTED OTHERWISE)

EACH TRUSS

ROOF PANELS, OVER 15# MIN. ROOFING

ROOF OVERHANG DETAIL

2'-Ø"

ON PRE-ENGINEERED TRUSSES AT 24" O.C. R-38 BATT INSULATION INSULATION BAFFLE BETWEEN EACH TRUSS - SIMPSON H2.5A (TYPICAL EACH TRUSS, UNLESS NOTED OTHERWISE) - 3 HOLE, 2" DIA. BIRDBLOCKING WITH INSECT SCREENS

-CONT. 4" ALUMINUM GUTTER $-CONT. 2 \times 8 PAINTED FASCIA$

- SIMPSON 'BC4' POST CAP (TYP.) - 4" ALUMINUM DOWNSPOUTS


AS SHOWN ON ROOF PLAN

 $_{-}$ 4 imes 4 PAINTED WOOD POST


-PAINTED 1/2" A/C PLYWOOD OR OSB

ATTACH ROOF SHEATHING W/ 8d COMMON NAIL (2 1/2" \times Ø.131") 6" O.C. AT EDGES, 12" O.C. FOR INTERMEDIATE SUPPORTS. PER IRC TABLE R602.3(1)

ROOF OVERHANG AT BEAM DETAIL

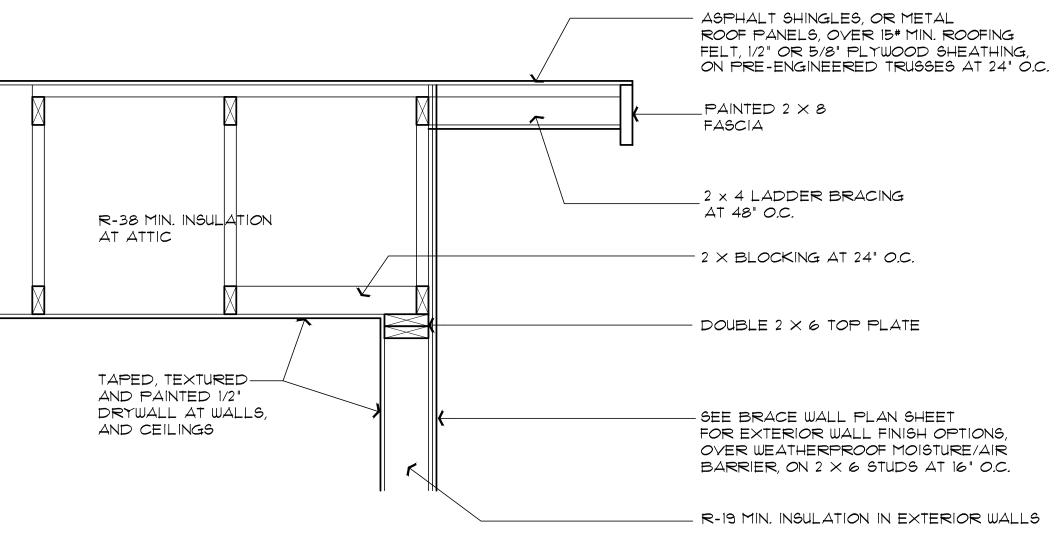


GABLE END-WALL DETAIL

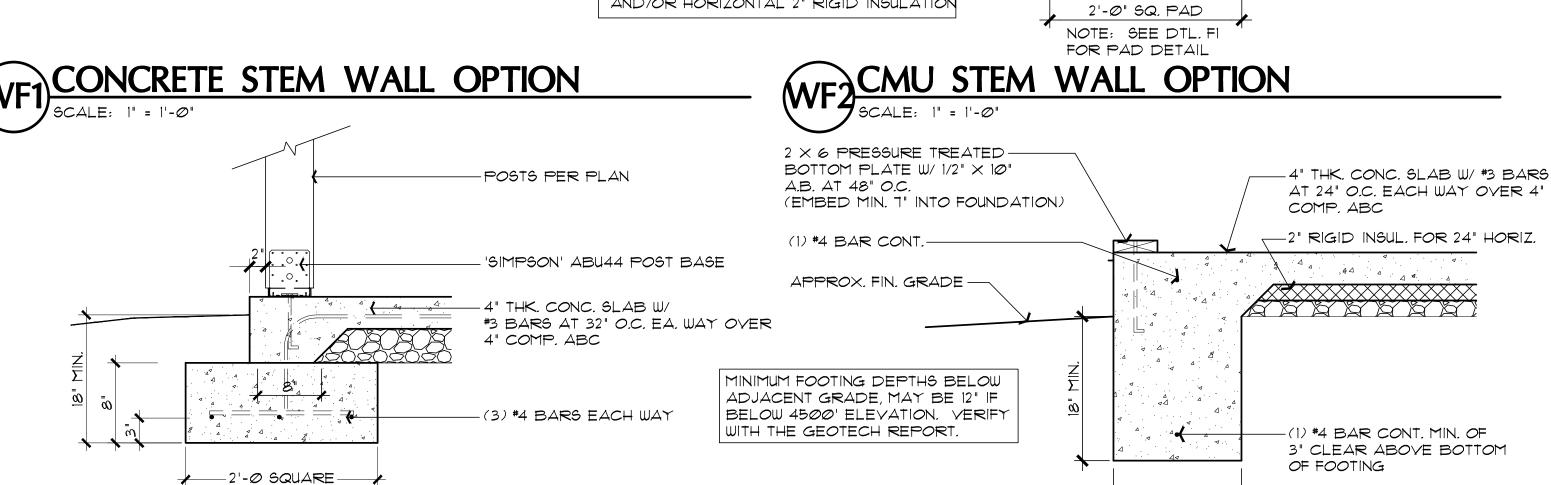

NOTE: SLAB INSULATION MAY BE ELIMINATED IF USING WINDOWS WITH 0.32 U-FACTOR OR BETTER.

MONOLITHIC FOOTING OPTION

SCALE: 1" = 1'-0"

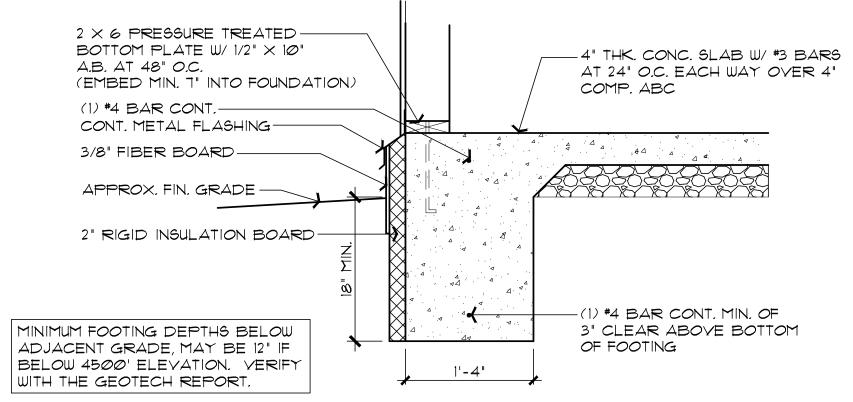

MONOLITHIC FOOTING OPTION WITH WF4 EXTERIOR SLAB INSULATION

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<u>MAY 24, 2024</u>

MFR

Drawn by

Chk'd by : MFR

Lange oger Mar


> DETAILS - LEFT PARKING **ARIZ** ROOF 1 BATH

FOUNDATION SE TWO - 1 BDRM


A - 7.0

SHEET NO:


HVAC PLAN (with furnace above habitable area)

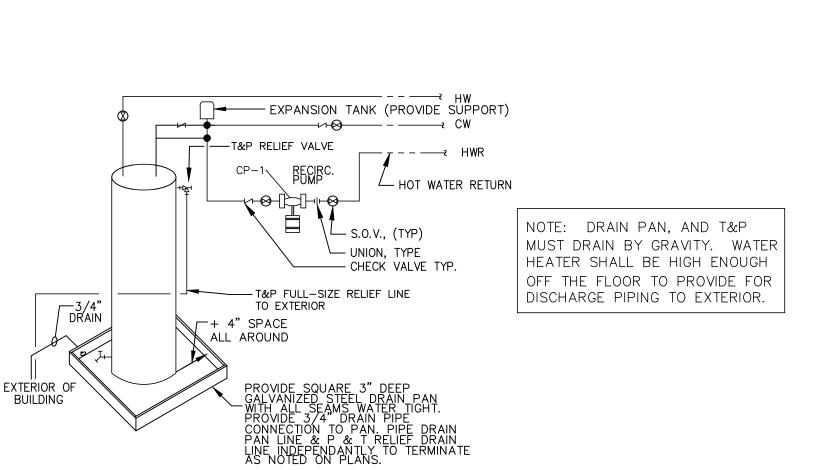

PROVIDE ACCESSABLE ELECTRICAL DISCONNECT **ELECTRIC WATER HEATER**

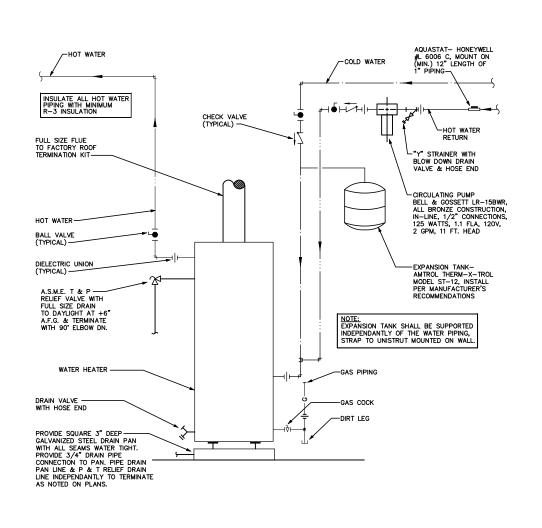

GAS WATER HEATER OPTION

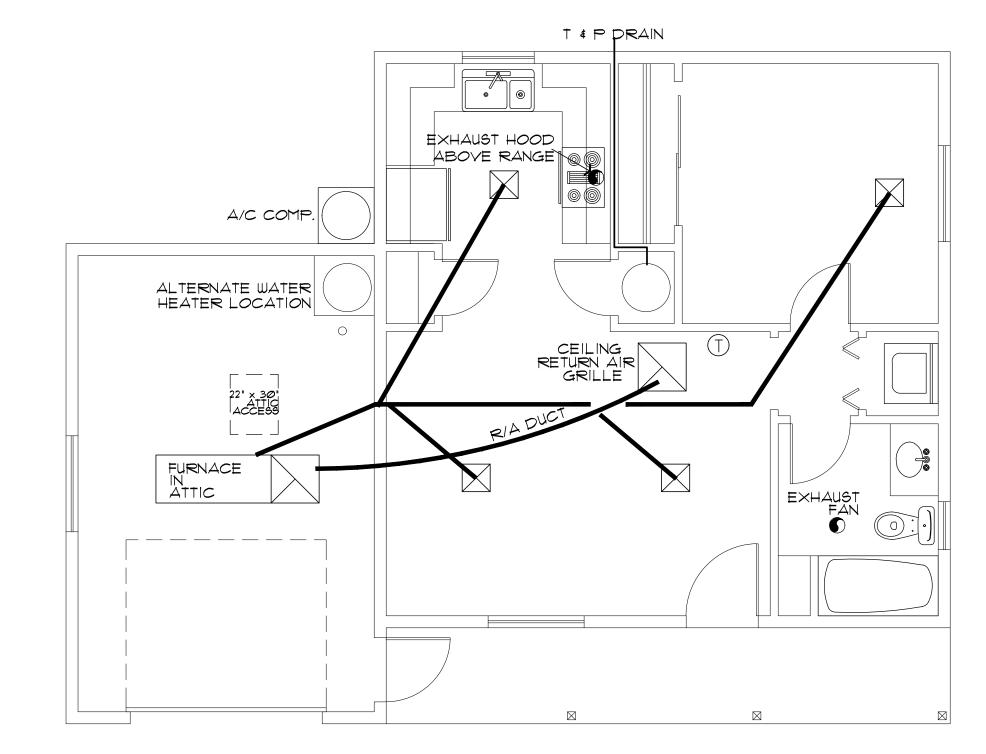

HVAC PLAN (with furnace above Garage / Carport)

(T) THERMOSTAT

HVAC/PLUMBING GENERAL NOTES:

1. THE MECHANICAL CONTRACTOR SHALL DETERMINE THE FINAL EQUIPMENT SIZING, DUCT SIZING, AND DUCT LAYOUT PRIOR TO INSTALLATION.


WITH THE END OF THE PIPE NOT MORE THAN 2' NOR LESS THAN 6" ABOVE THE GROUND AND POINTING DOWNWARD.

4. PROVIDE A PAN, AND DRAIN FOR THE WATER HEATER.

5. THE CLOTHES DRYER EXHAUST DUCT SHALL BE AT LEAST THE DIAMETER SHALL TERMINATE AT THE EXTERIOR OF THE BUILDING. IT SHALL NOT EXCEED 25' IN LENGTH WITH REDUCTIONS FOR BENDS. THE DUCT SHALL TERMINATE NOT LESS THAN 3' FROM A PROPERTY LINE.

6. THE SITE PLAN SHALL INDICATE THE LOCATION OF THE GAS SOURCE, THE DISTANCE AND PIPE SIZE FROM THE SOURCE, TO THE RESIDENCE, AND THE TYPE OF FUEL (NATURAL GAS OR PROPANE).

1. BI-FOLD DOOR AT WATER HEATER CLOSET SHALL BE LOUVERED FOR COMBUSTION AIR (MIN. REQUIREMENTS OF 100 SQ. INCHES OF FREE AIR).

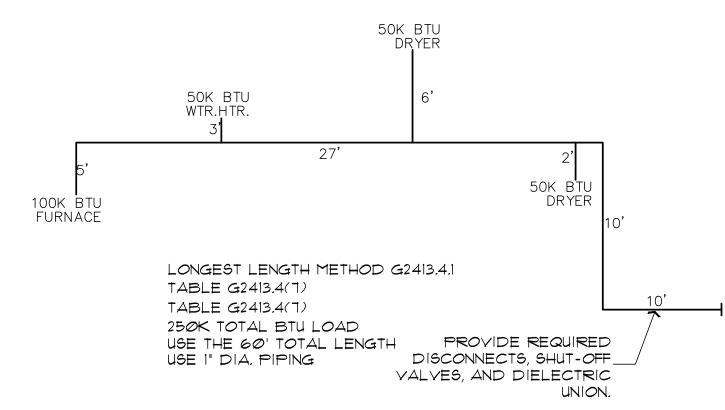

GAS PIPING ISOMETRIC


NO SCALE

NOTE: USE 1" DIA. PIPING FOR ALL FLOOR PLAN LAYOUTS, INCLUDING. ALTERNATE FIXTURE LOCATIONS. THE PLUMBING CONTRACTOR SHALL SHALL VERIFY ALL SIZING, AND FITTINGS, PRIOR TO INSTALLATION.

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once report to the Architect any error, inconsistancy or omission he may discover.



ARIZON

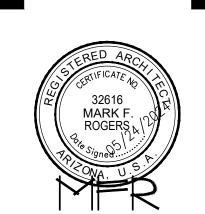PLANS NOTES - LEFT PARKING

ELECTRICAL / HVAC SYMBOL SCHEDULE / TWO - 1 BDRM / 1 BATH

SHEET NO:

M-1.0

ELECTRICAL SYMBOLS

+ WALL MOUNTED LIGHT FIXTURE

-CEILING MOUNTED LIGHT FIXTURE

-DAMP-PROOF CEILING MOUNTED LIGHT FIXTURE

- PENDANT LIGHT FIXTURE

- RECESSED CAN FIXTURE

1' imes 4' SURFACE MTD. FLUORESCENT FIXTURE

- 110v. DUPLEX CONVENIENCE OUTLET MOUNTED 12" A.F.F., OR AS NOTED

- 110v. 4-PLEX CONVENIENCE OUTLET MOUNTED 12" A.F.F., OR AS NOTED

-GROUND-FAULT INTERRUPT

-WEATHER-PROOF GROUND-FAULT INTERRUPT

--- 22ØV RECEPTACLE

- SINGLE POLE SWITCH MOUNTED

AT 48" OR AS NOTED -3-WAY SINGLE POLE SWITCH MOUNTED

AT 48" OR AS NOTED

- CEILING EXHAUST FAN

- SMOKE DETECTOR

- SMOKE DETECTOR / CARBON MONOXIDE COMBO

-CABLE TY OUTLET

— CEILING FAN W/ LIGHT KIT

- DOORBELL BUTTON

TELEPHONE OUTLET

ENERGY NOTES:

1. WINDOWS DOOR & SKYLIGHTS

*FENESTRATION U-FACTOR WINDOW AND DOORS TO BE .40 STICKER SHALL REMAIN ON WINDOWS, SKYLIGHTS & DOORS UNTIL INSPECTED AND APPROVED FOR THE ABOVE REQUIREMENT. THE FOUNDATION SLAB INSULATION MAY BE ELIMINATED IF USING A MAX. 0.32 U-FACTOR ON GLAZING.

2. CEILINGS

* CEILING INSULATION TO BE MIN. R-30 (ZONE 2)± R-38 (ZONE 4) MARKERS SHALL BE AFFIXED TO THE TRUSSES OR JOIST AND MARKED WITH THE MIN. ISTALLED THICKNESS BY ONE INCH HIGH NUMBERS. A MIN. OF ONE MARKER SHALL BE INSTALLED FOR EVERY 300 SQ. FT. OF AREA WITH NUMBERS TO FACE THE ATTIC ACCESS OPENING. MARKERS MUST BE INSTALLED AT ROUGH IN OR WALL INSULATION INSPECTIONS.

3. WOOD FRAMED EXTERIOR WALLS (MIN. R-19 FOR 2 X 6 WALLS) * WALL INSULATION SHALL BE IN SUBSTANTIAL CONTACT WITH THE SURFACE BEING INSULATED TO AVOID AIR PATHS THAT

BYPASS THE INSULATION. * INSULATION SHALL NOT BE COMPRESSED BY INSET STAPLING OF THE BATT INSULATION OR OTHER MEANS * INSULATION SHALL FILL ALL CAVATIES COMPLETLY BY CUTTING INSULATION AROUND ELECTRCAL OUTLETS AND SWITCHES AND BY SLICING INSULATION TO FIT BEHIND AND IN FRONT OF ELECTRICAL WIRING IN THE CAVITY AND PLUMBING PIPING

OF THE WALL SHALL BE INSULATED 4. NOT USED.

5. BUILDING THERMAL ENVELOPE

THE SEALING METHODS BETWEEN DISSIMILAR MATERAILS SHALL ALLOW FOR DIFFERENTAIL EXPANSION AND CONTRACTION. THE FOLLOWING SHALL BE CAULKED, GASKETED WEATHER STRIPPED OR OTHERWISE SEALED WITH AN AIR BARRIER MATERIAL, SUITABLE FILM OR SOLID MATERIAL:

* BAND JOISTS AND OTHER INTERSTITIAL FLOOR ELEMENTS

ELECTRICAL GENERAL NOTES

- 1. ALL WORKMANSHIP, MATERIALS, AND METHODS SHALL CONFORM TO N.E.C.- 2017 EDITION.
- 2. ALL HABITABLE ROOMS SHALL BE PROVIDED W/ ELECTRICAL OUTLETS SO THAT NO PART OF THE WALL IS MORE THAN 6' FROM AN OUTLET. WALL SECTIONS 2' OR LARGER & KITCHEN COUNTERS WIDER THAN 12" SHALL BE SERVICED BY A RECEPTACLE.
- 3. ALL RECEPTICALS IN BATHROOMS, OUTSIDE & WITHIN 6' OF WATER SOURCE SHALL BE G.F.C.I.
- 4. ALL SMOKE DETECTORS SHALL BE INTERCONNECTED ON SEPARATE
- CIRCUIT & SHALL RECEIVE PRIMARY POWER FROM BUILDING WIRING & SHALL HAVE BATTERY BACKUP. CONNECT NEW SMOKE DETECTORS TO NEW AUDIBLE SYSTEM INSIDE EXISTING RESIDENCE.
- 5. LIGHTS IN CLOSETS SHALL BE 18" FROM SHELVING (MEASURED HORZTL. OR BE RECESSED.
- 6. PROVIDE MINIMUM TWO 20A BRANCH CIRCUITS FOR RECEPTACLES LOCATED IN THE KITCHEN, PANTRY, EATING AREA, A SEPARATE 2014 BRANCH CIRCUIT TO THE LAUNDRY EQUIP., AND A SEPARATE 20A BRANCH CIRCUIT FOR BATHROOM RECEPTACLES.
- 7. ALL BRANCH CIRCUITS THAT SUPPLY 120-VOLT SINGLE PHASE 15 & 20 AMP OUTLETS INSTALLED IN FAMILY ROOMS, DINING ROOMS LIVING ROOMS, PARLORS, LIBRARIES, DENS, BEDROOMS, SUNROOMS RECREATION ROOMS, CLOSETS, HALLWAYS AND SIMILAR ROOMS OR AREAS SHALL BE PROTECTED BY COMBINATION TYPE ARC FAULT CURCUIT INTERUPTERS INSTALLED TO PROVIDE PROTECTION OF THE
- 8. FIXTURES, FITTINGS, BOXES AND RECEPTACLES LOCATED IN DAMP OR WET LOCATIONS SHALL BE 'LISTED' TO BE SUITABLE FOR SUCH CONDITIONS.
- 9. CONTRACTOR TO EMBED 20' OF #4 AWG COPPER WIRE IN FOOTING FOR ELECTRICAL SERVICE GROUND, PROVIDE BONDING TO THE INTERIOR WATER PIPING AND ABOVE GROUND PORTION OF GAS PIPING SYSTEM.
- 10. IN KITCHEN AND DINING ROOMS A RECEPTACLE OUTLET SHALL BE INSTALLED AT EACH WALL COUNTER SPACE 12" OR WIDER SO THAT AT NO POINT ALONG THE WALL 15 MORE THAN 24" FROM A RECEPTACLE OUTLET AND SHALL BE GFCI PROTECTED.
- 1. PROVIDE AT LEAST ONE WEATHER PROOF RECEPTACLE OUTLET NOT MORE THAN 6'-6" ABOVE GRADE AND GFC! PROTECTED.

 AT THE FRONT AND BACK OF EACH DWELLING, ALL RECEPTACLES INSTALLED OUTDOORS MUST BE GFC! PROTECTED.
- 12. ALL EXTERIOR LIGHTING SHALL CONFORM TO YAVAPAI COUNTY DARK SKY ORDINANCE.
- 13. IN ATTICS, A SERVICE OUTLET & LIGHTING FIXTURE LOCATED NEAR THE APPLIANCE REQUIRING SERVICE SHALL BE CONTROLLED BY A SWITCH AT THE ENTRY OF THE ATTIC. (REQUIRED FOR ATTIC MOUNT FURNACES)
- A. ALL JOINTS, SEAMS AND PENETRATIONS B. SITE BUILT WINDOWS, DOORS AND SKYLIGHTS C. OPENINGS BETWEEN WINDO AND DOOR ASSEMBLIES AND
- THEIR RESPECTIVE JAMBS AND FRAMING. D. UTILITY PENETRATIONS. E. DROPPED CEILINGS OR CHASES ADJACENT TO THE THERMAL ENVELOPE.
- F. KNEE WALLS G. WALLS AND CEILINGS SEPERATING GARAGE FROM
- CONDITIONED SPACES. H. BEHIND TUB AND SHOWERS ON EXTERIOR WALLS I. COMMEN WALLS BETWEEN DWELLING UNITS J. OTHER SOURCES OF INFILTRATION.

6. FENESTRATION AIR LEAKAGE

* WINDOW, SKYLIGHT AND SLIDING GLASS DOOR SHALL HAVE AN AIR INFILTRATION RATE OF NO MORE THAN 0.3 CFM PER SQUARE FOOT, AND SINGING DOORS NO MORE THAN 0.5 CFM SPECIFICATIONS SHALL BE LISTED ON THE MANUF. LABEL. (USE TYVEK HOUSE WRAP, INSTALL PER MANUF. SPECS)

1. RECESSED LIGHTING

RECESSED LUMINAIRES INSTALLED IN THE BUILDING THERMAL ENEVELOPE SHALL BE SEALED TO LIMIT AIR LEAKAGE BETWEEN CONDITIONED AND UNCONDITIONED SPACES BY


- A. IC RATED AND LABELED WITH ENCLOSURES THAT ARE SEALED OR GASKETED TO PREVENT AIR LEAKAGE TO CEILING CAVITY OR UNCONDITIONED SPACE + OR B. IC RATED AND LABELED AS MEETING ASTM E 283± OR C. LOCATED INSIDE AIRTIGHT SEALED BOX WITH CLEARANCES OF AT LEAST Ø.5 INCH FROM COMBUSTIBLE MATERIAL AND
- 8. HEAT PUMP SUPPLEMENTARY HEAT

3 INCHEDS FROM INSULATION.

* HEAT PUMPS HAYING SUPPLEMENTARY ELECTRIC- RESISTANCE HEAT SHALL HAVE CONTROLS THAT, EXCEPT DURING DEFROST PREVENT SUPPLEMENTAL HEAT OPERATION WHTN THE HEAT PUMP COMPRESSOR CAN MEET THE HEATING LOAD.

* AT LEAST ONE THERMOSTAT SHALL BE PROVIDED FOR EACH SEPARATE HEATING & COOLING SYSTEM.

- * SUPPLY AND RETURN DUCTS SHALL BE INSULATED TO A MIN. OF R-8 (EXCEPT DUCTS THAT COMPLETLY INSIDE THE BUILDING THERMAL ENVELOPE.)
- * ALL DUCTS, AIR HANDLERS, FILTER BOXES, AND BUILDING CAVITIES (NOT FOR AIR SUPPLY) USED AS DUCTS SHALL BE SEALED. JOINTS AND SEAMS SHALL COMPLY WITH SECTION
- 12. MECHANICAL SYSTEM PIPING INSULATION * MECHANICAL SYSTEM PIPING CAPABLE OF CARRYING FLUIDS ABOVE 105 D. F OR BELOW 55 D. F SHALL BE INSULATED TO A MIN. OF R-2
- 13. CIRCULATING HOT WATER SYSTEMS
- * ALL CIRCULATING SERVICE HOT WATER PIPING SHALL BE INSULATED TO AT LEAST R-2. ALL NEW RESIDENCES WITH 2 OR MORE BATHROOMS SHALL HAVE A
- CIRCULATING HOT WATER SYSTEM. CHWS SHALL INCLUDE AN AUTOMATIC OR READILY ACCESSIBLE MANUAL SWITCH THAT CAN TURN OFF THE HWCP WHEN THE SYSTEM IS NOT IN USE. THERMAL SIPHONING SYSTEMS SHALL HAVE A VALVE TO REDUCE FLOW. ALTERNATE SYSTEM SHALL BE CONSIDERED.
- 14. MECHANICAL VENTIALTION
- *OUTDOOR AIR INTAKES AND EXHAUST SHALL HAVE AUTOMATIC GRAVITY DAMPER THAT CLOSE WHEN THE VENTILATION SYSTEM IS NOT OPERATING.
- 15. EQUIPTMENT SIZING
- *HEATING & COOLING EQUIPTMENT SHALL BE SIZED IN ACCORDANCE WITH SECTION M1401.3 OF THE IRC.
- 16. AIR LEAKAGE
- AIR FLOW RETARDERS (HOUSE WRAPS) MUST BE: A. IMPERMEABLE TO AIR FLOW.
- B. CONTINOUS OVER THE ENTIRE BUILDING ENVELOPE
- C. ABLE TO WITHSTAND THE FORCES THAT MAY ACT ON IT DURING AND AFTER CONSTRUCTION.
- D. DURABLE OVER THE EXPECTED LIFETIME OF THE BUILDING. E. ALL SEAMS AND EDGES MUST BE SEALED/TAPED PER MANUF SPECIFICATIONS

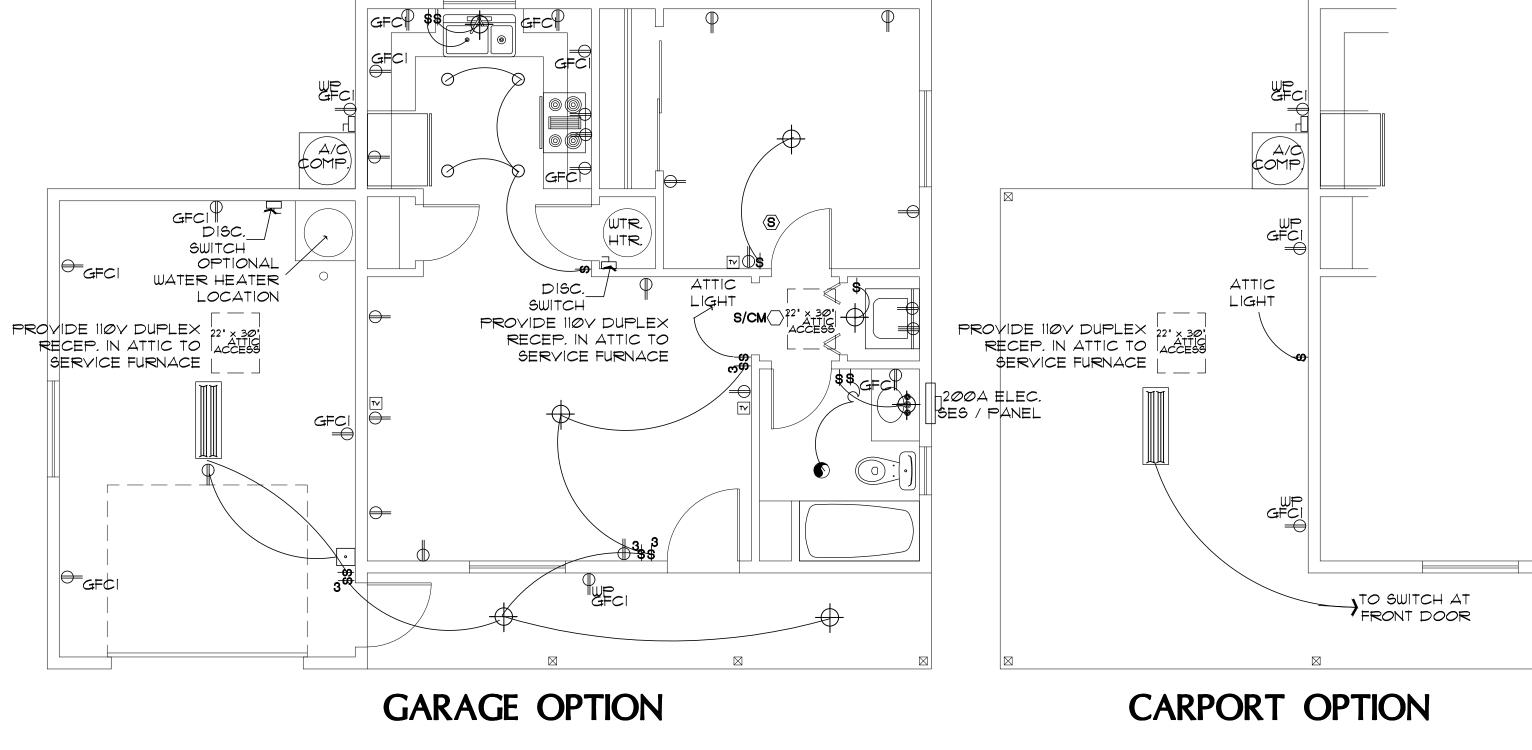

ELECTRICAL PLAN

SCALE: 1/4" = 1'-0"

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SCHE

B

SYMI

M

: 1BM/1BA LEFT

AS NOTED

MFR

<u>MFR</u>

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32616

ROGERS N

8

MARK F

tancy or omission he may discover.

It is to be returned upon request.

Date

Scale Revisions:

Drawn by

Chk'd by:

<u>MAY 24, 2024</u>

SHEET NO:

PROPERTY OF YAVAPAI COUNTY. AZ