2018 IRC - IBC

2006 **IECC**

CALL TWO WORKING DAYS BEFORE YOU DIG

1-800-STAKE-IT (1-800-782-5348) YAVAPAI COUNTY

2018 IRC R311.3 There shall be a floor or landing on each side of the exterior door. The width of the landing shall not be less than the door served with a minimum distance of 36" measured in the direction traveled.

The inspector may require further clarification on stamped plans. This may include, but not limited to a special inspection and /or a cross section detail stamped and signed by the Designer/Architect/Engineer of record.

DEVELOPMENT SERVICES *PARCEL *OWNER/APPLICANT PERMIT #:

* Information required to be filled out by the applicant.

HOME OF MY OWN - 2 BED LEFT (2024 PLANS)

/

CAUTION

Yavapai County permitted building plans do not relieve the Owners or General Contractor from their responsibilities to conform to all adopted building codes. Every effort has been made to provide a thorough plan review, however plans may contain irregularities. If plans do not contain the proper information or details the Owner/General Contractor Shall Not proceed with the project until the issue has been resolved through Yavapai County and any professional involved in the project

Yavapai County Ordinance, Section 112.6

Drainage across Property Lines.

Drainage across property lines shall not exceed that

which existed prior to grading. Excess or concentrated

drainage shall be contained on site or

directed to an approved drainage facility. Erosion of the

ground in the area of discharge shall be

prevented by installation of non-erosive down-drains or

other devices.

Per 2018 IRCR309.1, R309.2, and IBC 406.3.3: Garage/ carport surfaces used for parking of vehicles shall be sloped to drain liquids to the main vehicle entry doorway or an approved drain

Effective April 20, 2006, **Fully shielded fixtures are** required for all exterior lamps

The mechanical equipment, design and system have been reviewed for the basic design ONLY. The HVAC contractor shall review the plans/ calculations to assure the design is adequate and complies with all applicable codes and installation

THE ENGINEERED **GEOTECHNICAL REPORT IS A** PART OF THE PERMITTED

DOCUMENTS, AND SHALL BE ONSITE AT ALL TIMES WITH THE PERMITTED PLANS.

Applicant acknowledges that plans stamped by a

registrant will not be fully reviewed by staff and

that approvals are contingent upon favorable

field inspections. Should conditions in the field

prove non-conducive to code requirements,

significant delays may be realized. Applicant

attests that the sealed plans are in compliance

with all applicable codes and ordinances

Per Article 210.12 of the **2017 NEC**

Arc fault circuit interupters are required

A separate permit for alternative

electric source is required. The

alternative electric source

permit will need to be issued

and finalized before a building

final can be obtained

THE GAS PIPING INSTALLER SHALL **VERIFY THE SYSTEM IS OF SUCH SIZE** FOR THE MAXIMUM DEMAND AND TO **MEET EACH APPLIANCE INLET AT NOT** LESS THAN THE MINIMUM SUPPLY PRESSURE REQUIRED

Foam spray shall comply with the ES Reports

and applicable codes. It is the responsibility

of the owner and/or contractor(s) to review

reports and understand requirements before

application, Ignition/thermal barrier is

required unless otherwise exempt. Failure to

comply may cause additional cost to the

owner/contractor(s).

THIRD PARTY SPECIAL INSPECTIONS REQUIRED: (Third party special inspections are not in lieu of required building inspections.) YES

The following items require special inspections:

YAVAPAI

PROJECT:

- SOILS CONDITION
- SOILS COMPACTION
- BOTTOM OF FOOTING COMPACTION
- AND OTHER INSPECTIONS REQUIRED BY THE GEOTECHNICAL ENGINEER.

Reports to be supplied to the Building Inspector

It is imperative that the owner /contractor print ALL permit documents from the online portal before inspection.

CAUTION:

Areas within Yavapai County are likely to have expansive, compressible, shifting or other unknown soils conditions. The building official may require a soils test to determine the soils characteristic at a particular location.

GENERAL GRADING NOTES:

Where the lot line walls, slopes, or other physical barriers prohibit 6" of fall within 10', drains or swales shall be provided to insure drainage away from the structure. **MAINTAIN MINIMUM 2:1 SLOPE**

The faces of cut and fill slopes shall be prepared and maintained to control against erosion. The protection for the slopes shall be installed as soon as practicable and prior to requesting final approval. NO GRADING WITHIN 2' OF PROPERTY LINES

aps

Contact APS BEFORE you start construction; APS Prescott Office: 928-443-6797; Prescottcontroldesk@apsc.com APS Cottonwood Office: 928-646-8502; Verdecontroldesk@apsc.com

APS Wickenburg Office: 602-371-6200; Wickenburg controldesk@apsc.co

The property owner shall be responsible to verify fire sprinkler requirements with the governing fire district

Provide at least one window or exterior door approved for emergency escape or rescue for every room used for sleeping purposes. 2018 IRC R310.1

Interconnected smoke detectors are required for this project per **2018 IRC R314.3.1. Each sleeping** room, outside each sleeping room and on each floor level.

APPROVAL IS SUBJECT TO FIELD INSPECTION AND COMPLIANCE WITH **ALL RELEVANT CODES,** LAWS AND ORDINANCES

RAIN GUTTERS & DOWNSPOUTS

is required. Refer to the geotechnical report for an additional requirements

IMPORTANT! Footings will not be inspected until the property corners are properly pinned, flagged and easily identifiable to the building inspector.

Slab insulation shall be approved for the under slab application. Provide an ES No slab grade or floor framing Report and manufacturer's specifications if not using the pre-approved products inspections will be conducted

- 1. Extruded polystyrene insulation Dow square edge (Blue)
- 2. Extruded polystyrene Owen corning Foamular 250 (Pink)

Per 2018 YCABC Ordinance 2014-1 Section 110.3.4: **Pre-slab inspections are required**

without compaction reports.

ARE REQUIRED

Positive drainage away from the structure

Reviewed for Design Criteria Only

Truss calculations to be on site at the time of frame inspection

BIG STAMP

BOARD OF SUPERVISORS

CRAIG BROWN, CHAIRMAN - DISTRICT 4

DONNA G. MICHAELS, Ph.D., VICE CHAIR - DISTRICT 3

HARRY B. OBERG, MEMBER - DISTRICT 1

MARY MALLORY, MEMBER - DISTRICT 5



DEVELOPMENT SERVICES

JEREMY DYE, DIRECTOR MARK LUSSON, ASSISTANT DIRECTOR WARREN COLVIN, CHIEF BUILDING OFFICIAL

SE

\$2

SHEET NO:

JAMES GREGORY, MEMBER - DISTRICT 2

HOME OF MY OWN Phase Two Single-Family Housing TWO BEDROOM / TWO BATH - LEFT PARKING

1015 Fair Street Prescott, Arizona

INDEX TO DRAWINGS

COVER SHEET W/ PROJECT INFORMATION FLOOR PLANS / OPENING SCHEDULES FOUNDATION PLANS ROOF FRAMING PLANS BRACE WALL PLANS A - 4.0EXTERIOR ELEVATIONS **BUILDING SECTIONS** A-6.0A - 7.0**DETAILS MECHANICAL** M-1.0**ELECTRICAL** E-1.0

PROJECT INFORMATION

ALL WORK SHALL CONFORM TO ALL YAVAPAI COUNTY ADOPTED CODES, ORDINANCES AND POLICIES, INCLUDING BUT NOT LIMITED TO THE FOLLOWING: 2018 INTERNATIONAL RESIDENTIAL CODE (IRC) 2018 INTERNATIONAL PLUMBING CODE (IPC) 2018 INTERNATIONAL MECHANICAL CODE (IMC) 2017 NATIONAL ELECTRIC CODE (NEC) 2006 INTERNATIONAL ENERGY CONSERVATION CODE (IECC)

LIVABLE: 1,080 SQ. FT. CARPORT/ALT. GARAGE: 517 SQ. FT 144 SQ. FT. **COVERED ENTRY: TOTAL UNDER ROOF:** 1,741 SQ. FT.

OPTION WITHOUT GARAGE, OR CARPORT LIVABLE: 1,080 SQ. FT. **COVERED ENTRY:** 144 SQ. FT TOTAL UNDER ROOF: 1,224 SQ. FT.

OCCUPANCY: R-3 (Single-Family Residential) CONSTRUCTION TYPE: V-B

THESE HOMES WERE DESIGNED FOR A MAXIMUM ELEVATION OF 6200 FEET (40 LB. SNOW LOAD). THEY WERE NOT DESIGNED FOR A TILE ROOF.

GENERAL NOTES

I. DUE TO REPROGRAPHIC PROCESS, THESE PLANS MAY NOT BE ACCURATE TO SCALE. DIMENSIONS ARE NOT TO BE SCALED FROM THE WORKING DRAWINGS.

2. BEFORE ORDERING ANY MATERIALS OR STARTING ANY WORK, CONTRACTORS SHALL VERIFY ALL MEASUREMENTS AND EXISTING CONDITIONS AT THE SITE AND SHALL BE RESPONSIBLE FOR THE CORRECTNESS OF THE SAME. ANY DEVIATION AND/OR UNSAFE OR UNREGULATED CONDITIONS SHALL BE BROUGHT TO THE ATTENTION OF YAVAPAI COUNTY DEVELOPMENT SERVICES.

3. GENERAL CONTRACTOR TO VERIFY AND LOCATE ALL UTILITY STUB OUTS AND MAINS BEFORE BEGINNING CONSTRUCTION OF PROJECT.

4. GENERAL CONTRACTOR TO VERIFY THE REMOVAL AND/OR REPLANTING OF LANDSCAPE IF THE CONDITION OCCURS OVER THE PROJECT SITE.

5. DAMAGE TO SITE, UTILITIES, OR NEWLY BUILT IMPROVEMENTS, NOT DESIGNED FOR REMOVAL, SHALL BE THE RESPONSIBLITY OF THE GENERAL CONTRACTOR INVOLVED, AND SHALL BE REPAIRED OR REPLACED AT THE


6. VERIFY UNIFORMITY OF ALL FRAMING SO AS TO CREATE A SMOOTH, REGULAR FINISH WITH NO IRREGULARITIES.

7. IT IS THE RESPONSIBILTY OF THE GENRAL CONTRACTOR, TO THOROUGHLY REVIEW THE PLANS AND TO NOTIFY YAVAPAI COUNTY DEVELOPMENT SERVICES OF ANY DISCREPANCIES. YAVAPAI COUNTY, NOR THE ARCHITECT-OF-RECORD, WILL NOT BE RESPONSIBLE FOR MATERIALS IMPROPERLY ORDERED OR INSTALLED.

8. FAILURE BY THE GENERAL CONTRACTOR, OR SUB-CONTRACTORS, TO AQUAINT THEM-SELVES WITH ALL AVAILABLE INFORMATION CONCERNING THIS PROJECT SHALL NOT RELIEVE THEM OF THE RESPONSIBILITY TO PERFORM THEIR WORK PROPERLY

- 9. APPROVAL OF ALL CONSTRUCTION IS SUBJECT TO FIELD VERIFICATION BY YAVAPAI COUNTY PERSONELL.
- 10. EVERY SLEEPING ROOM SHALL HAVE AT LEAST ONE (1) OPERATING WINDOW, OR DOOR, FOR EMERGENCY EGRESS, OPEN DIRECTLY TO A STREET, ALLEY, OR YARD.

PROPERTY OF YAVAPAI COUNTY. AZ

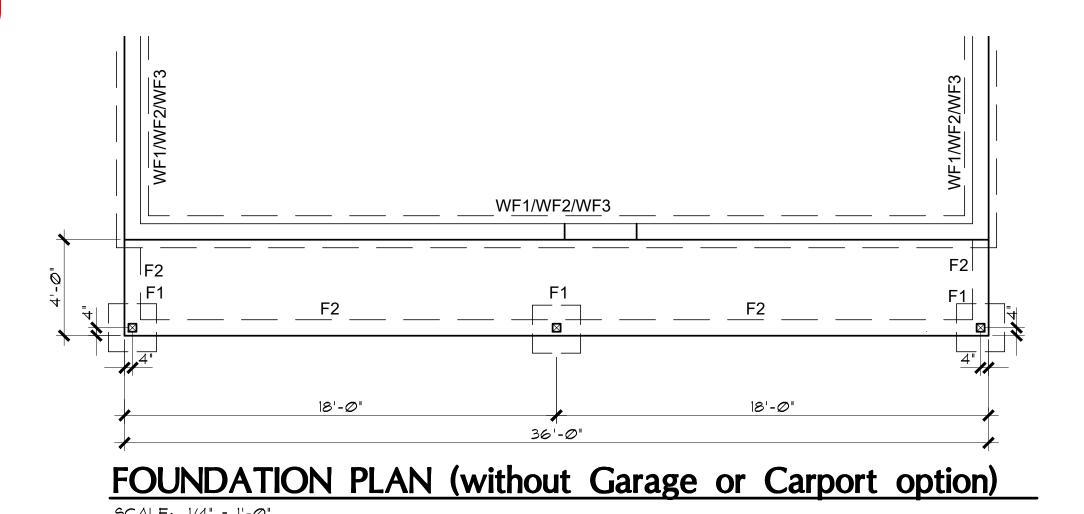


FOUNDATION NOTES

- 2. FOOTINGS AND INTERIOR FLATWORK TO BE MIN.
- 2500 P.S.I. MIN COMPRESSIVE STRENGTH AT 28 DAYS. 3. FOUNDATION SUPPORTED WOOD TO EXTEND MIN. 6" ABOVE
- 4. FOUNDATION PLATES AND SILLS SHALL BE BOLTED TO FOUNDATION WITH MIN. 1/2" BOLTS 6'-0" O.C., 12" FROM CORNERS AND EMBEDDED 7" INTO FOUNDATION WALL
- 5. EXTERIOR FLATWORK SLOPE TO BE 1/4" PER FOOT.
- 6. CONTRACTOR TO EMBED 20' OF #4 G.A. COPPER WIRE IN FOOTING FOR ELECTRICAL SERVICE GROUND.
- 7. THE GRADE AWAY FROM FOUNDATION WALLS SHALL FALL A MINIMUM OF 6 INCHES WITHIN THE FIRST 10 FEET.
- 8. ALL EXTERIOR PLATES, LOAD BEARING AND NON LOAD BEARING
- SHALL BE PRESSURE TREATED, LESS THAN 8" ABOVE GRADE
- 9. FILL BEING PLACED THAT EXCEEDS 2' WILL REQUIRE A CERTIFIED

NOTE: THE FOOTINGS SIZE, THICKNESS, AND BOTTOM OF FOOTING DEPTH

SHALL BE PER THE GEOTECHNICAL REPORT/ENGINEER'S REQUIREMENTS. THIS SHALL INCLUDE ANY OVER EXCAVATIONS, ENGINEERED PAD REQUIREMENTS, AND/OR A CHANGE IN DEPTH, AND TYPE OF BASE COURSE UNDER THE CONCRETE SLABS.

SEE SHEET A-7.0 FOR FOOTING DETAILS

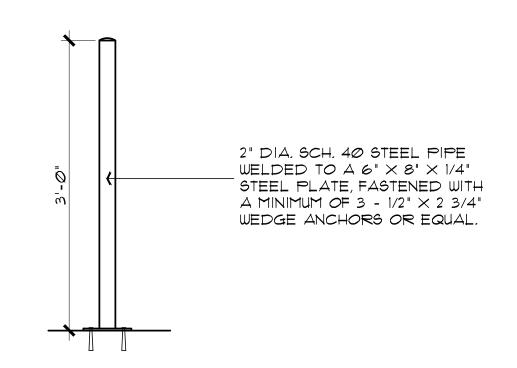


BOLLARD DETAIL

SCALE: 1/4" = 1'-0" THIS DETAIL APPLIES ONLY IF THE WATER HEATER IS LOCATED IN THE GARAGE.




SCALE: 1/4" = 1'-0"

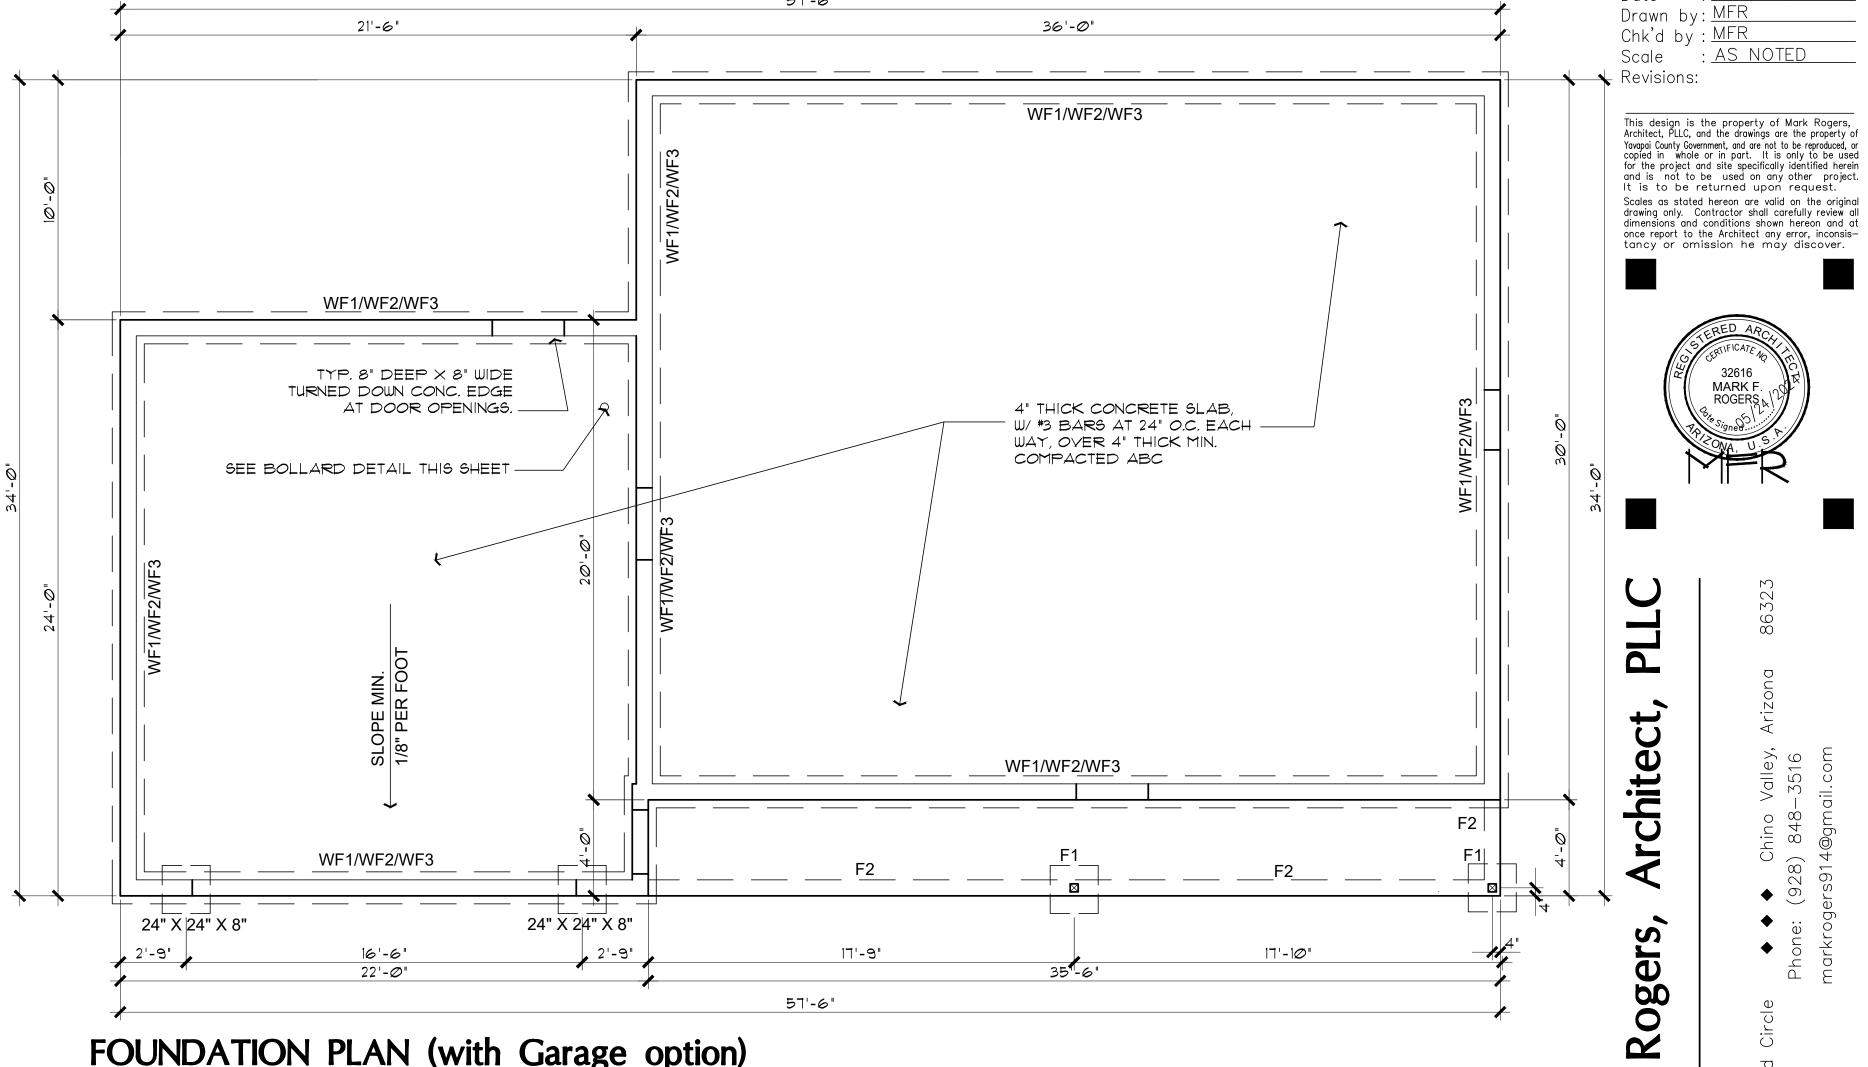

57'-6"

FOUNDATION PLAN (with Garage option)

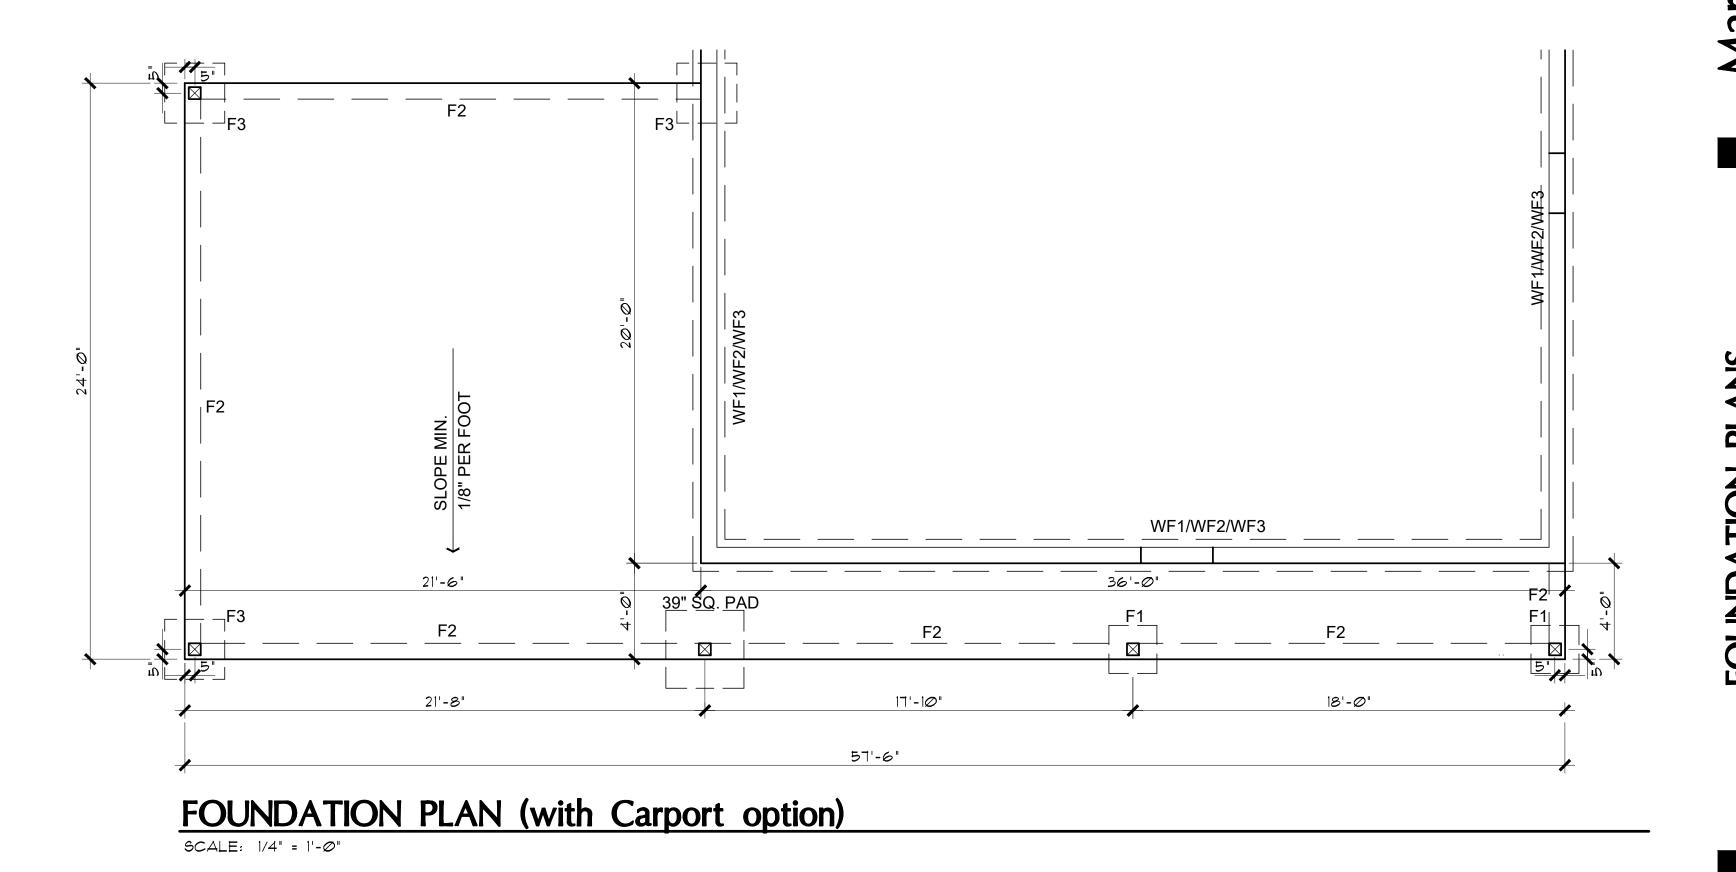


A-2.0

SHEET NO:

MAY 24, 2024

: AS NOTED

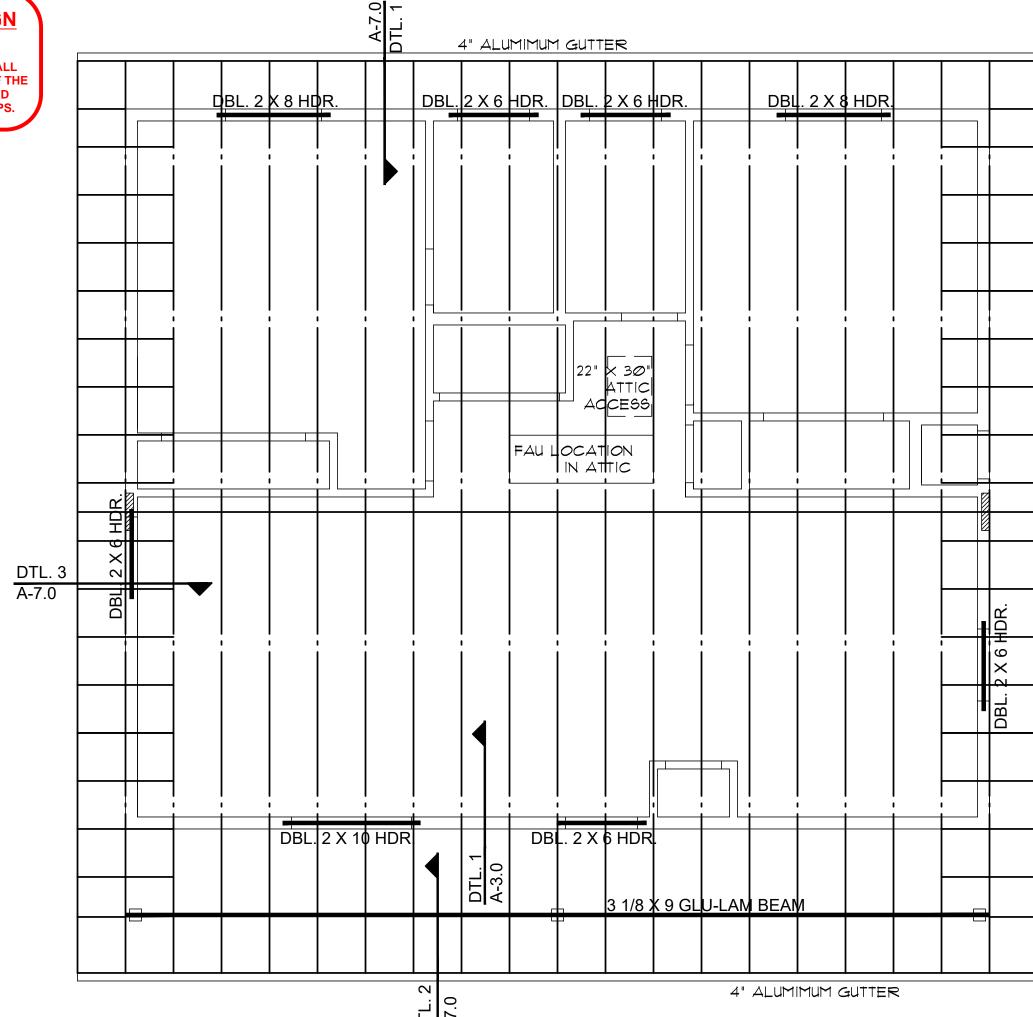


ROOF FRAMING PLAN (without optional Garage, or Carport) SCALE: 1/4" = 1'-0"

ROOF VENTILATION REQUIRED 1224 SQ. FT. / 300 = 4 SQ. FT. (864 SQ. IN.) USE 2 GABLE-END VENTS AT 144 SQ. IN. MINIMUM EACH VENT 288 SQ. IN. AT GABLE ENDS 288 SQ. IN. MIN, BIRDBLOCKS TO PROVIDE FOR LOW VENTILATION

24" O.C.

2018 IRC FIGURE R602.10.8.2(3)

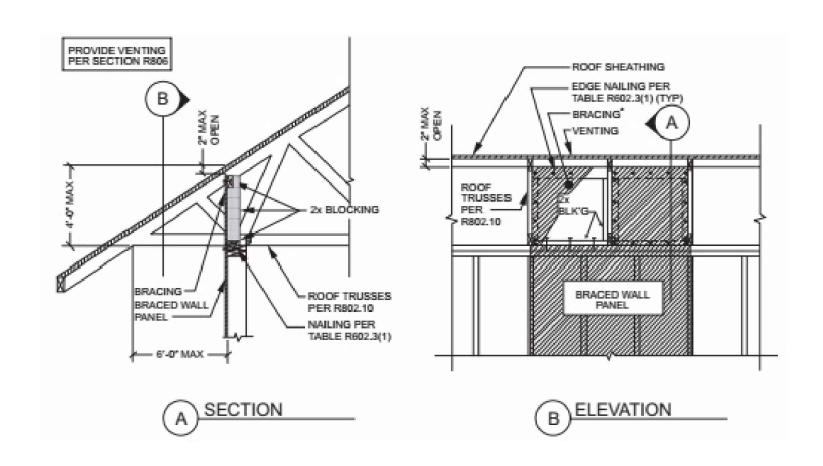


BRACED WALL PANEL CONNECTION OPTION AT PERPENDICULAR ROOF TRUSSES SCALE: 1 1/2" = 1'-Ø" 2018 IRC FIGURA

ROOF NOTES


- I. REFER TO TRUSS CALCULATIONS FOR FINAL ROOF FRAMING DESIGN.
- 2. SIMPSONS H2.5A HANGERS TO BE APPLIED @ ALL TRUSS ENDS
- 4. ROOF SHEATHING TO BE 1/2" CDX PLYWOOD OR OSB.
- 5. SUPPORTED MEMBERS OF G.L.B. & GIRDERS OR OTHER CONCENTRATED LOADS SUPPORTED BY WALL OR PIER SHALL HAVE BEARING AT LEAST AS WIDE AS THE ROOF
- 6. ROOF PITCH 4:12 (TYP.).
- 7. OVERHANGS TO BE 24".
- 8. FURNACE IN ATTIC: PROVIDE A 24" SOLID PASSAGEWAY TO CONTROL SIDE OF APPLIANCE AND A 30" SERVICE SPACE ON THE CONTROL SIDE OF THE APPLIANCE (REQUIRED FOR ATTIC MOUNT FURNACES)
- 9. ALL RAFTERS SHALL BE DOUGLAS FIR #2 (SIZE PER PLAN) ALL STUDS SHALL BE HEM FIR #2 (SIZE PER PLAN)

SEE ROOF FRAMING DETAILS SHEET A7.0

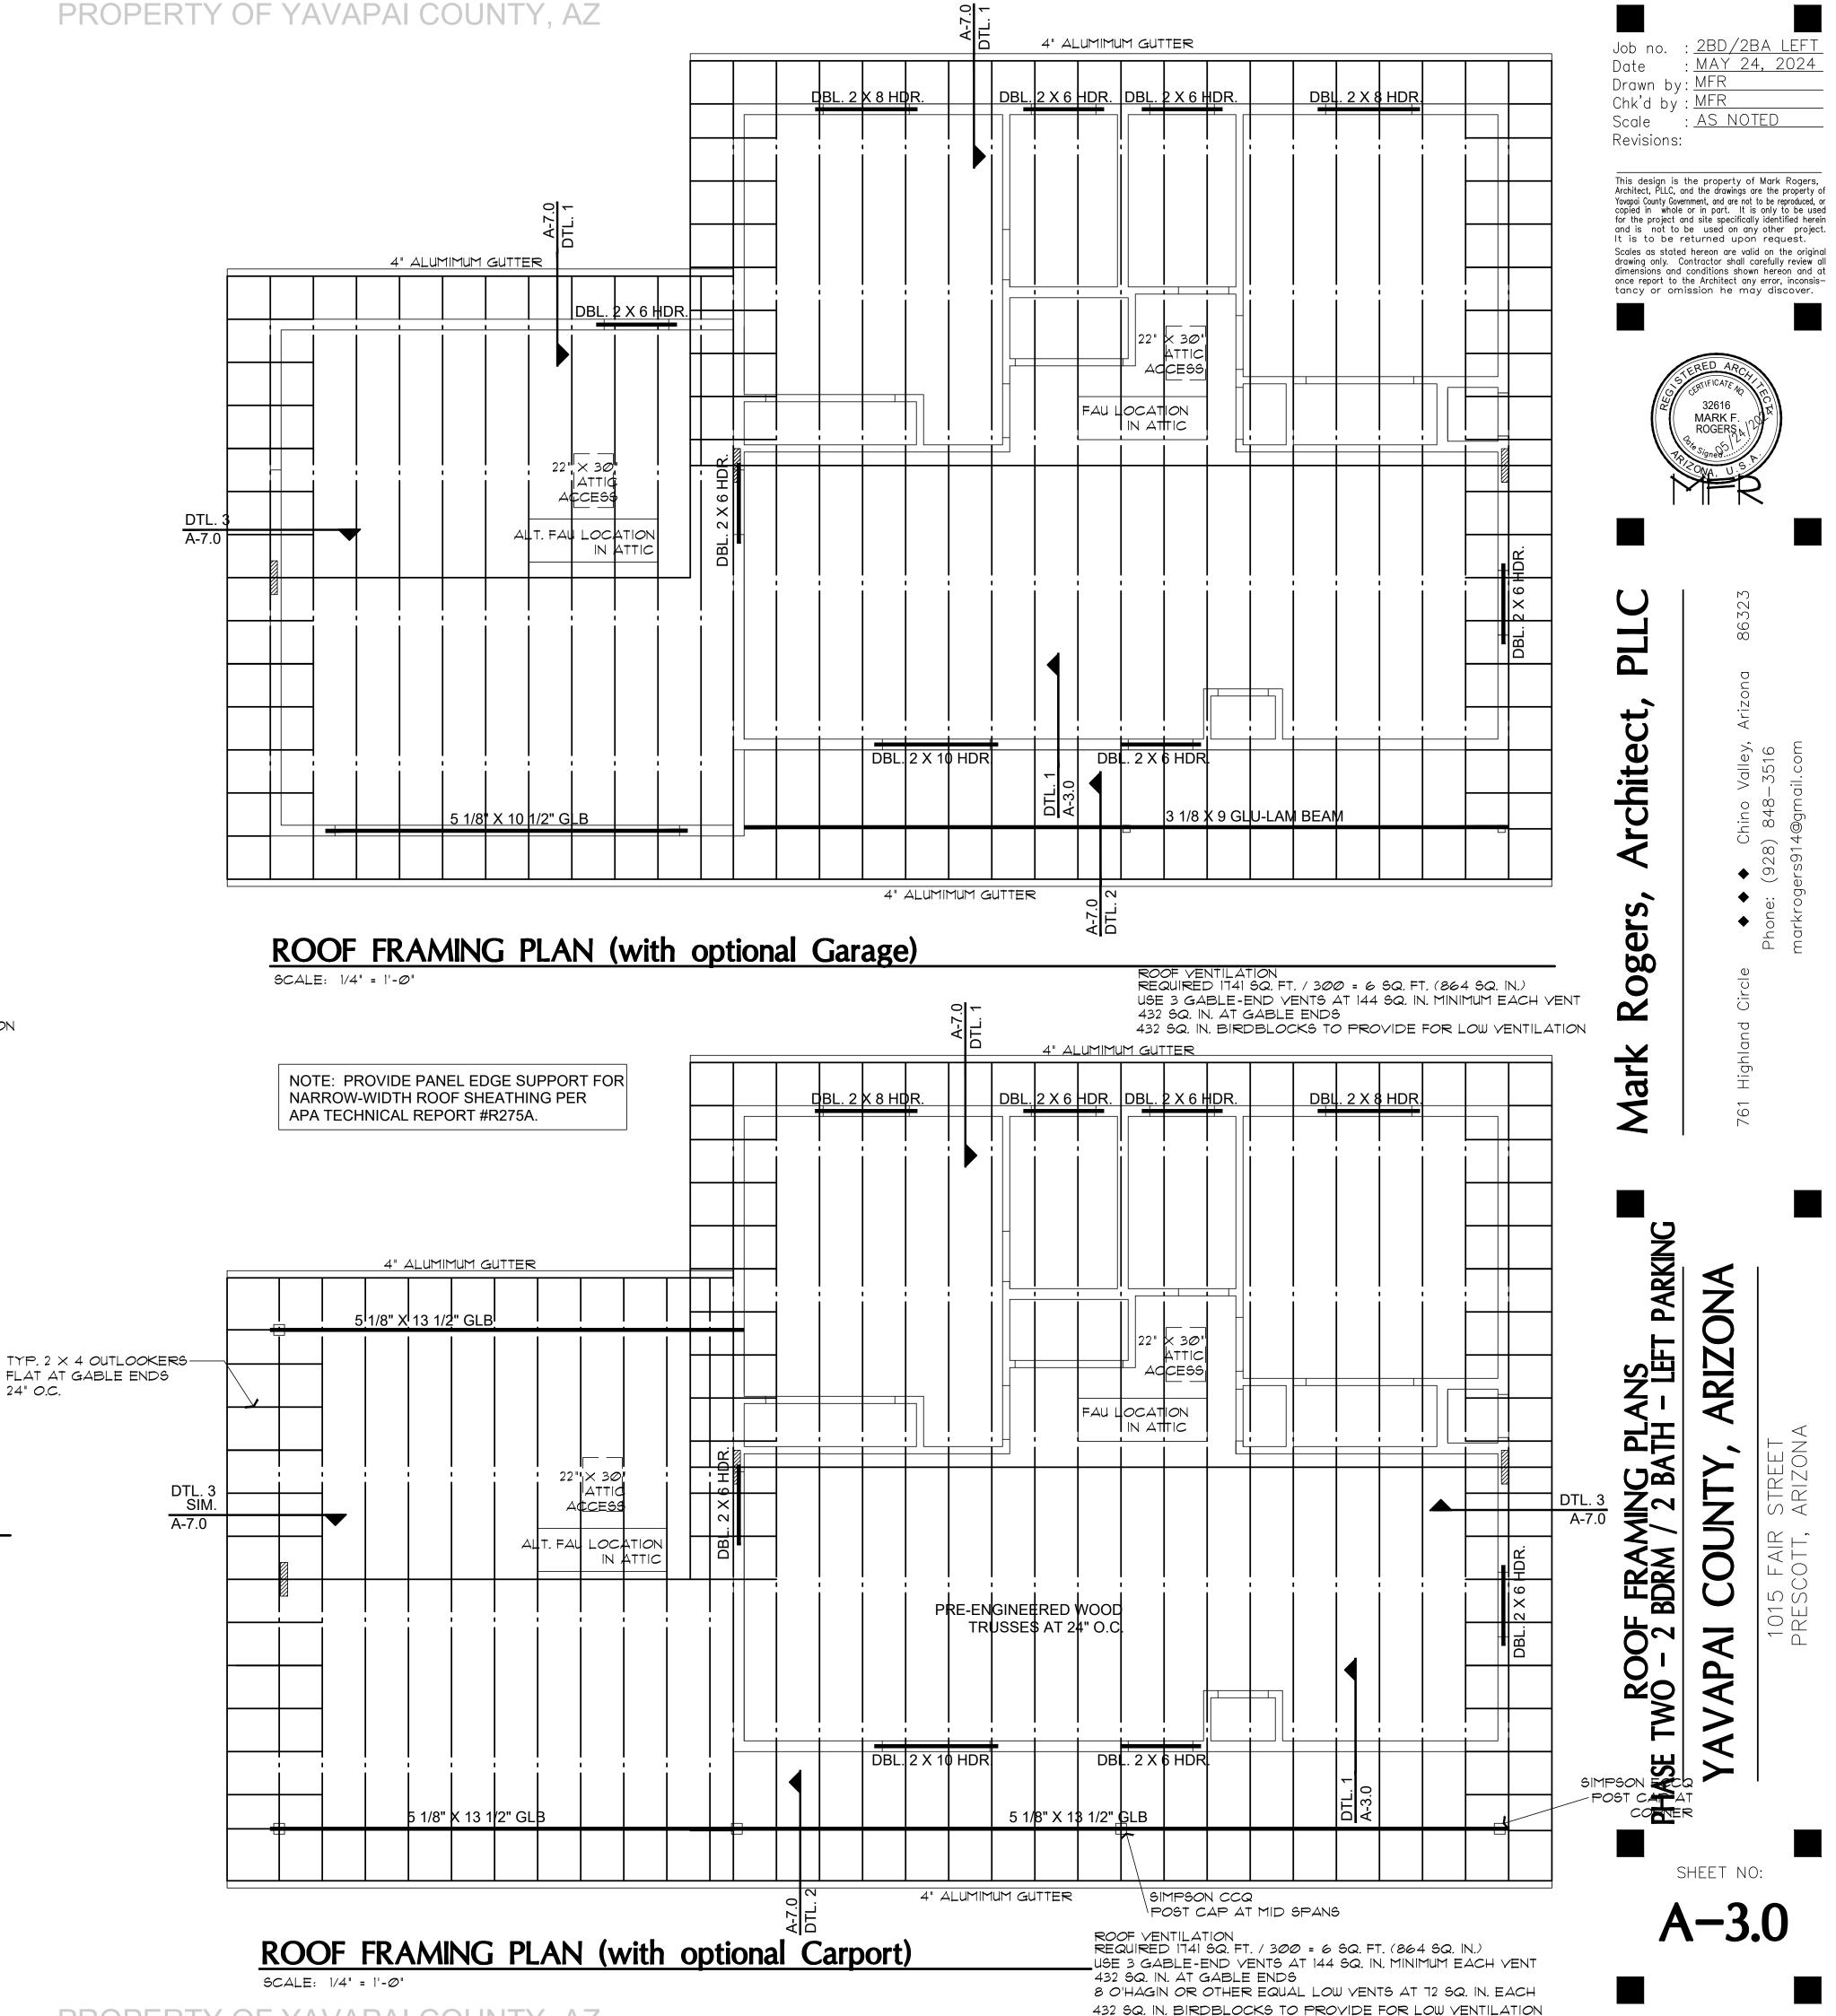

						1		1					
	WIND SPEED (MPH)			115		115		115		115		115	
	BRACED WALL LINE			Α		В		С					
	STORY												
BR	BRACED WALL PANEL METHOD			CS-WSP CS-PF CS-G		GB		CS-WSP CS-PF CS-G					
	AVG BWL SPACING (ft)			34		34		24					
	TABULAR REQUIRED (ft)	5.10		10.70		3.90		İ					
	EXPOSURE		С	1.20	С	1.20	С	1.20	С		С		
	EAVE-RIDGE HT (ft)		6.00	0.76	6.00	0.76	6.00	0.76					
Ė	STORY HEIGHT (ft)		9.00	0.95	9.00	0.95	9.00	0.95					
T ME	# BWLs		3.00	1.30	3.00	1.30	3.00	1.30					
ADJUSTMENT	ADD PAIR 800# HOLD DO	WNS	ИО	1.00	NO	1.00	NO	1.00					
₹	OMIT INTERIOR GB		NO	1.00	NO	1.00	NO	1.00					
	METHOD GB FASTEN @ 4" o.c		NO	1.00	NO	1.00	NO	1.00					
	HORIZONTAL BLOCKING OMITTED		NO	1.00	NO	1.00	NO	1.00					
F	REQUIRED BWP LENGTH (ft)		5.74		12.05		4.39						
	CONTRIBUTING LENGTH	BWP	METHOD	LENGTH (ft)	METHOD	LENGTH (ft)	METHOD	LENGTH (ft)	METHOD	LENGTH (ft)	METHOD	LENGTH (ft)	
		1	CS-WSP	4.00	CS-WSP	10.00	CS-WSP	4.00					
₽ E		2	CS-WSP	4.00	DS - GB	8.00	CS-WSP	4.00					
ACTUAL BWP		3	CS-WSP	4.00	CS-WSP	4.00							
, TC		4											
¥		5											
		6											
		7											
	ACTUAL BWP LENGTH (ft)			12.00		22.00		8.00					
	ACTUAL ≥ REQUIRED			YES		YES		YES					
SPACE	BWPs ≤ 20' APART		YES		YES		YES						
# of	Length of BWL (ft)		30		34		24						
BWPs	BWP 1 ≤ 16', 2 > 16'		YES		YES		YES						
ENDS	BWP WITHIN 10' OF END		YES	YES	YES	YES	YES	YES					
	CONTINUOUS END CONDITION		3	3	3	3	3	3					
В	BWL COMPLIANCE PASS-FAIL			ASS	F	ASS	F	ASS					

WIND SPEED (MPH)												
WIND SPEED (MPH)			115		115		115		115		115	
BRACED WALL LINE			1	2				Α		В		
STORY												
BRACED WALL PANEL METHOD			CS-VSP CS-PF CS-G		CS-WSP CS-PF CS-G				CS-WSP CS-PF CS-G		CS-WSP CS-PF CS-G	
AVG BWL SPACING (ft)			36		36				30		30	
TABULAR REQUIRED (ft)			5.40		5.40				4.50		4.50	
EXPOSURE		С	1.20	С	1.20	C		С	1.20	С	1.20	
EAVE-RIDGE HT (ft)		6.00	0.76	6.00	0.76			6.00	0.76	6.00	0.76	
STORY HEIGHT (ft)		9.00	0.95	9.00	0.95			9.00	0.95	9.00	0.95	
# BWLs		2.00	1.00	2.00	1.00			2.00	1.00	2.00	1.00	
ADD PAIR 800# HOLD DOWNS		NO	1.00	NO	1.00			NO	1.00	NO	1.00	
OMIT INTERIOR GB		NO	1.00	NO	1.00			NO	1.00	NO	1.00	
METHOD GB FASTEN @ 4" o.c		NO	1.00	NO	1.00			NO	1.00	NO	1.00	
HORIZONTAL BLOCKING OMITTED		NO	1.00	NO	1.00			NO	1.00	NO	1.00	
REQUIRED BWP LENGTH (ft)		4.68		4.68				3.90		3.90		
CONTRIBUTING LENGTH	BWP	METHOD	LENGTH (ft)	METHOD	LENGTH (ft)	METHOD	LENGTH (ft)	METHOD	LENGTH (ft)	METHOD	LENGTH (ft)	
	1	CS-WSP	4.00	CS-WSP	4.00			CS-W\$P	4.00	CS-WSP	4.00	
	2	CS-WSP	4.00	CS-WSP	4.00			CS-WSP	4.00	CS-WSP	4.00	
	3	CS-WSP	4.00	CS-WSP	4.00			CS-WSP	4.00	CS-WSP	4.00	
	4											
	5											
	6											
	7											
ACTUAL BWP LENGTH (ft)			12.00		12.00				12.00		12.00	
ACTUAL ≥ REQUIRED			YES		YES				YES		YES	
BWPs ≤ 20' APART		YES		YES				YES		YES		
Length of BWL (ft)		30		30				36		36		
BWP 1 ≤ 16', 2 > 16'		YES		YES				YES		YES		
BWP WITHIN 10' OF END		YES	YES	YES	YES			YES	YES	YES	YES	
CONTINUOUS END CONDITION		3	3	3	3			3	3	3	3	
BWL COMPLIANCE PASS-FAIL			PASS		PASS				PASS	PASS		
	CED WALL PANEL METHO AVG BWL SPACING (ft) ABULAR REQUIRED (ft) EXPOSURE EAVE-RIDGE HT (ft) # BWLs ADD PAIR 800# HOLD DO OMIT INTERIOR GB METHOD GB FASTEN @ 4 ORIZONTAL BLOCKING OF QUIRED BWP LENGTH (ft) CONTRIBUTING LENGTH CONTRIBUTING LENGTH BWPs ≤ 20' APART Length of BWL (ft) BWP 1 ≤ 16', 2 > 16' BWP WITHIN 10' OF EN CONTINUOUS END CONDI	CED WALL PANEL METHOD AVG BWL SPACING (ft) ABULAR REQUIRED (ft) EXPOSURE EAVE-RIDGE HT (ft) # BWLS ADD PAIR 800# HOLD DOWNS OMIT INTERIOR GB METHOD GB FASTEN @ 4" o.c. ORIZONTAL BLOCKING OMITTED QUIRED BWP LENGTH (ft) 2 3 4 5 6 7 CTUAL BWP LENGTH (ft) ACTUAL > REQUIRED BWPs ≤ 20' APART Length of BWL (ft) BWP 1 ≤ 16', 2 > 16' BWP WITHIN 10' OF END CONTINUOUS END CONDITION	CED WALL PANEL METHOD AVG BWL SPACING (ft) ABULAR REQUIRED (ft) EXPOSURE EAVE-RIDGE HT (ft) # BWLs ADD PAIR 800# HOLD DOWNS OMIT INTERIOR GB MO METHOD GB FASTEN @ 4" o.c ORIZONTAL BLOCKING OMITTED ORIZONTAL BLOCKING	X		X	CED WALL PANEL METHOD CS-WSPCS-PFCS-G CS-WSPCS-PFCS-G CS-WSPCS-PFCS-G ANG BWL SPACING (ft) 36 36 36 ABULAR REQUIRED (ft) 5.40 EXPOSURE C EAVE-RIDGE HT (ft) STORY HEIGHT (ft) 4.00 ADD PAIR 800# HOLD DOWNS ADD PAIR 800# HOLD DOWNS METHOD GB FASTEN @ 4" o.c OMIT INTERIOR GB MCETHOD GB FASTEN @ 4" o.c OWIT BWP LENGTH (ft) CCS-WSP CONTRIBUTING LENGTH CONTRIBUTING LENGTH T STORY BWP LENGTH (ft) T STORY HEIGHT (ft) 1.00 0.95 9.00 0.95	CED WALL PANEL METHOD	Sed Wall Panel Method	CED WALL PANEL METHOD CS-WSP CS-PF CS-G CS-WSP CS-PF CS-G AND BWL SPACING (ft) 36 36 30 ABULAR REQUIRED (ft) 5.40 EXPOSURE C 1.20 C 1.20 C 1.20 EAVE-RIDGE HT (ft) 6.00 0.76 6.00 0.76 6.00 0.76 STORY HEIGHT (ft) 9.00 0.95 9.00 0.95 # BWLs 2.00 1.00 ADD PAIR 800# HOLD DOWNS NO 1.00 NO	CED WALL PANEL METHOD	

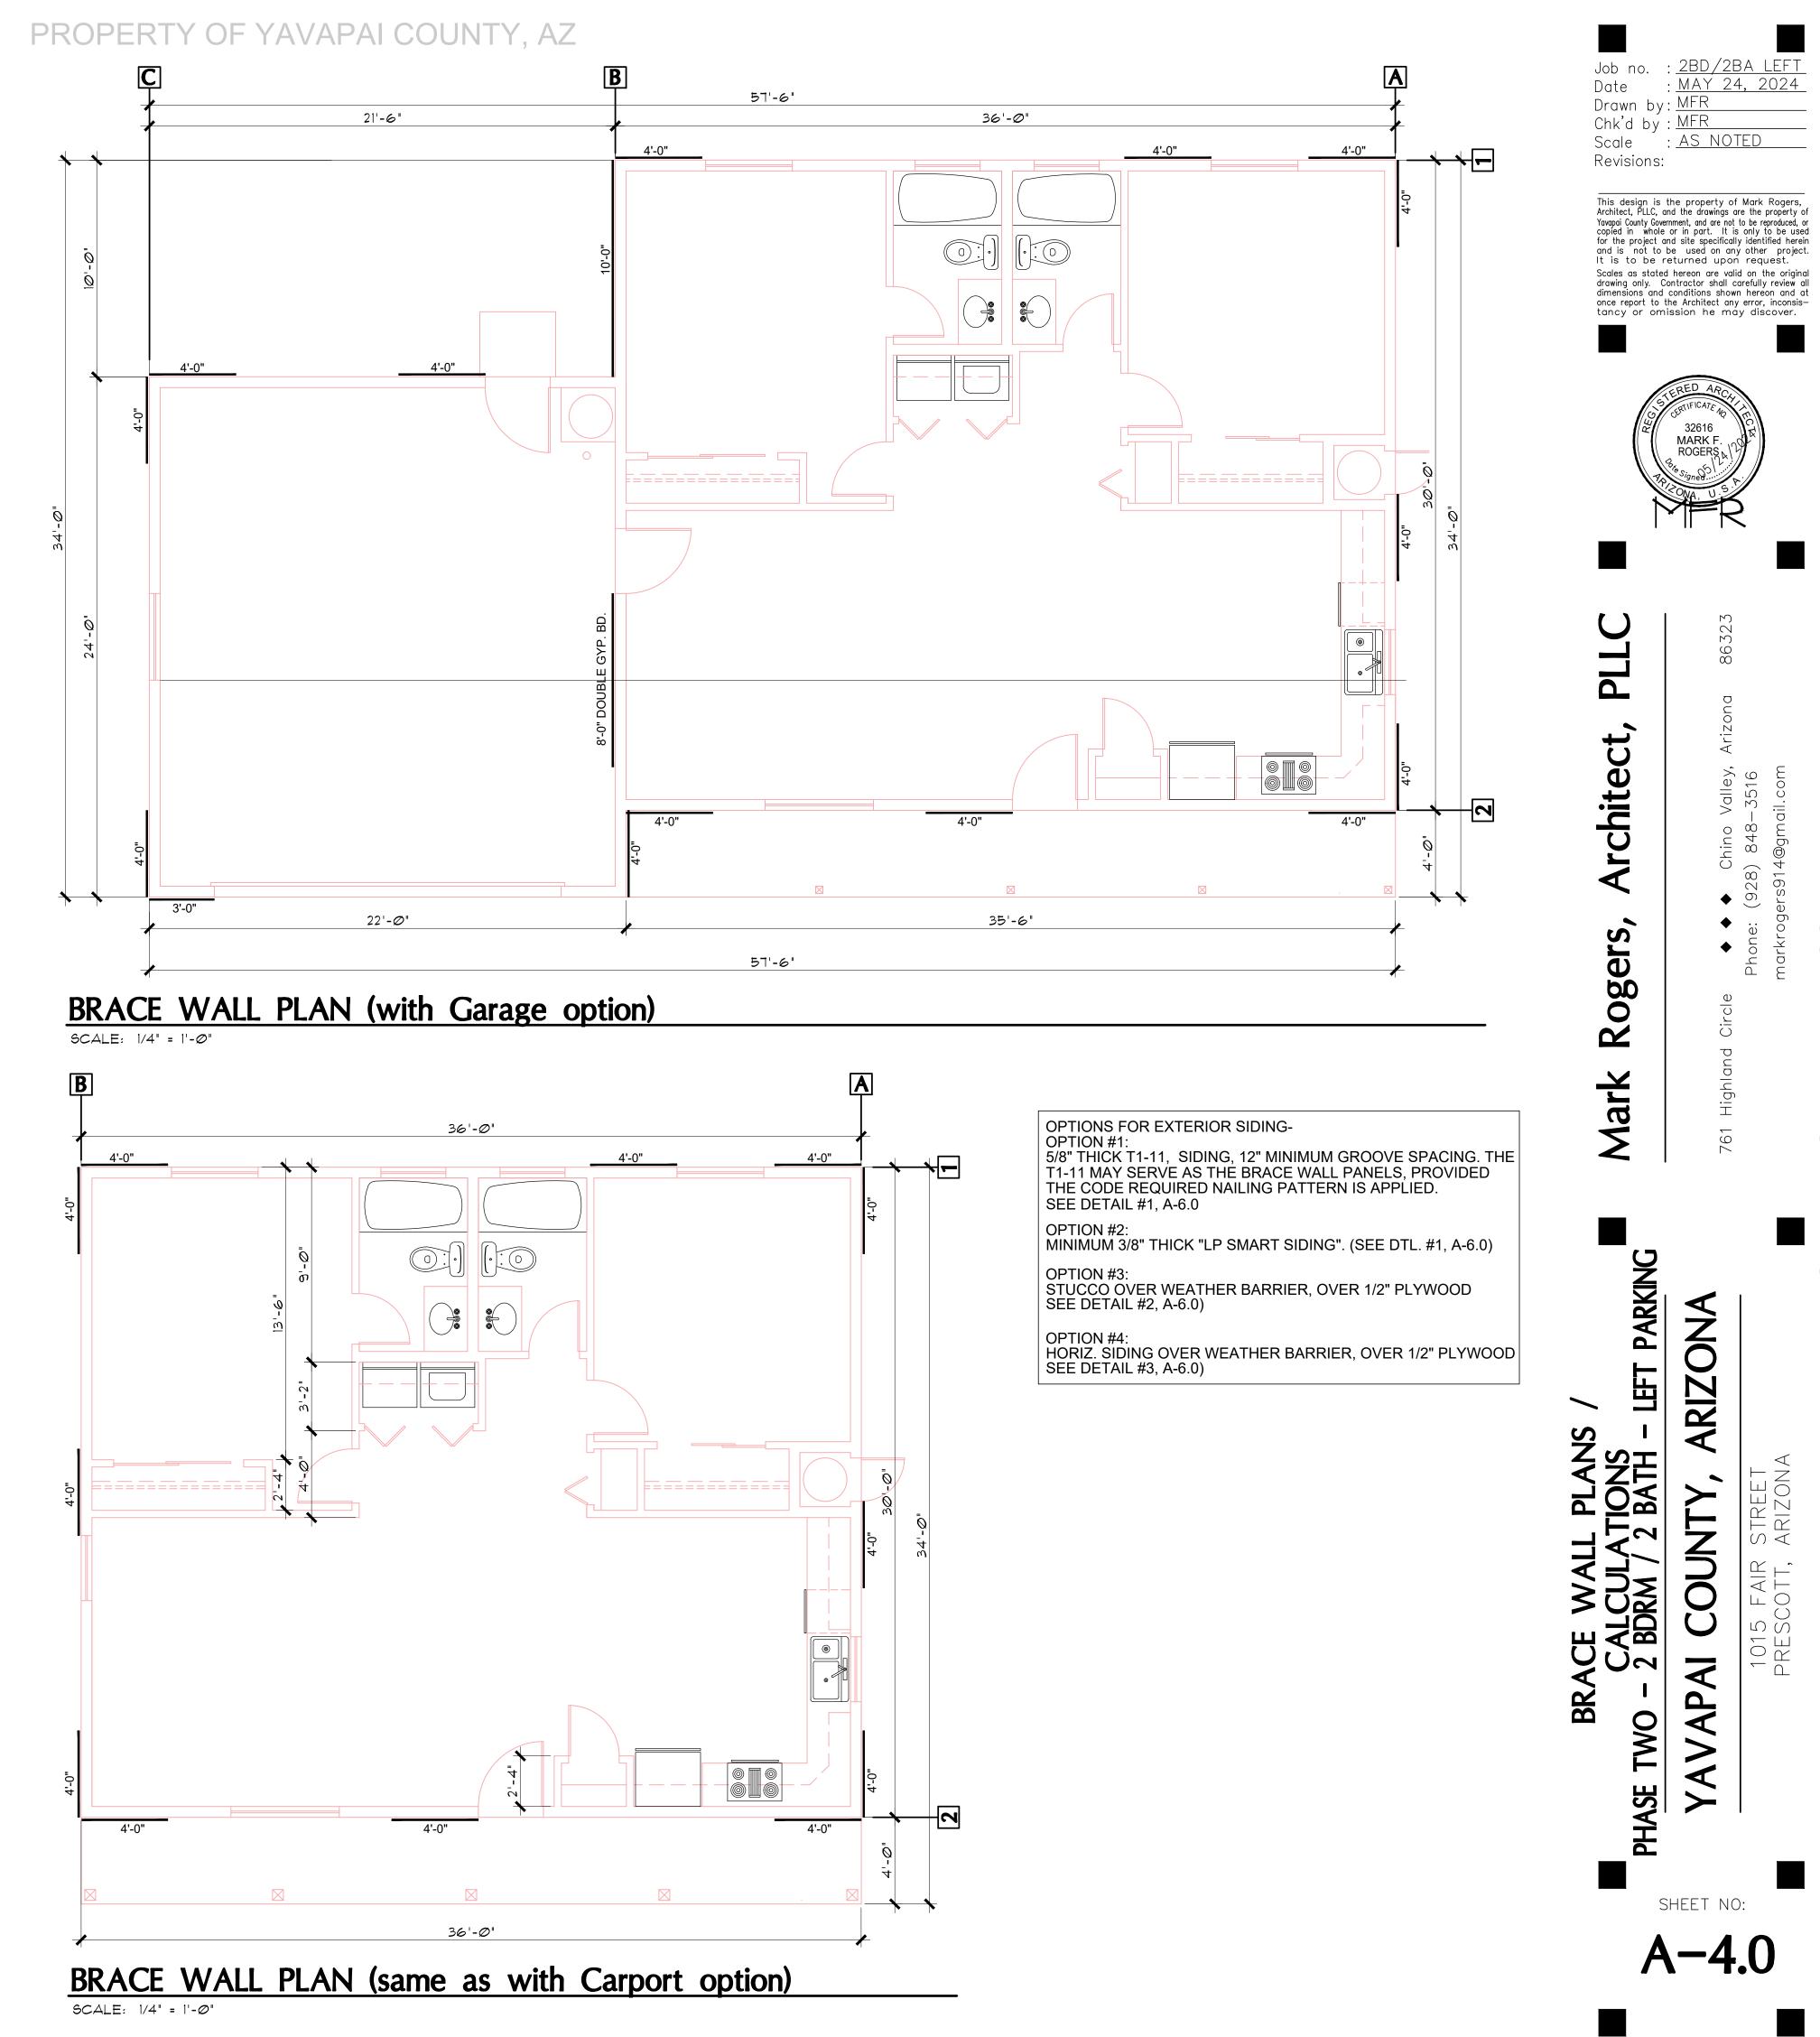


: MAY 24, 2024

: AS NOTED

Marl

SHEET NO:

PROPERTY OF YAVAPAI COUNTY. AZ

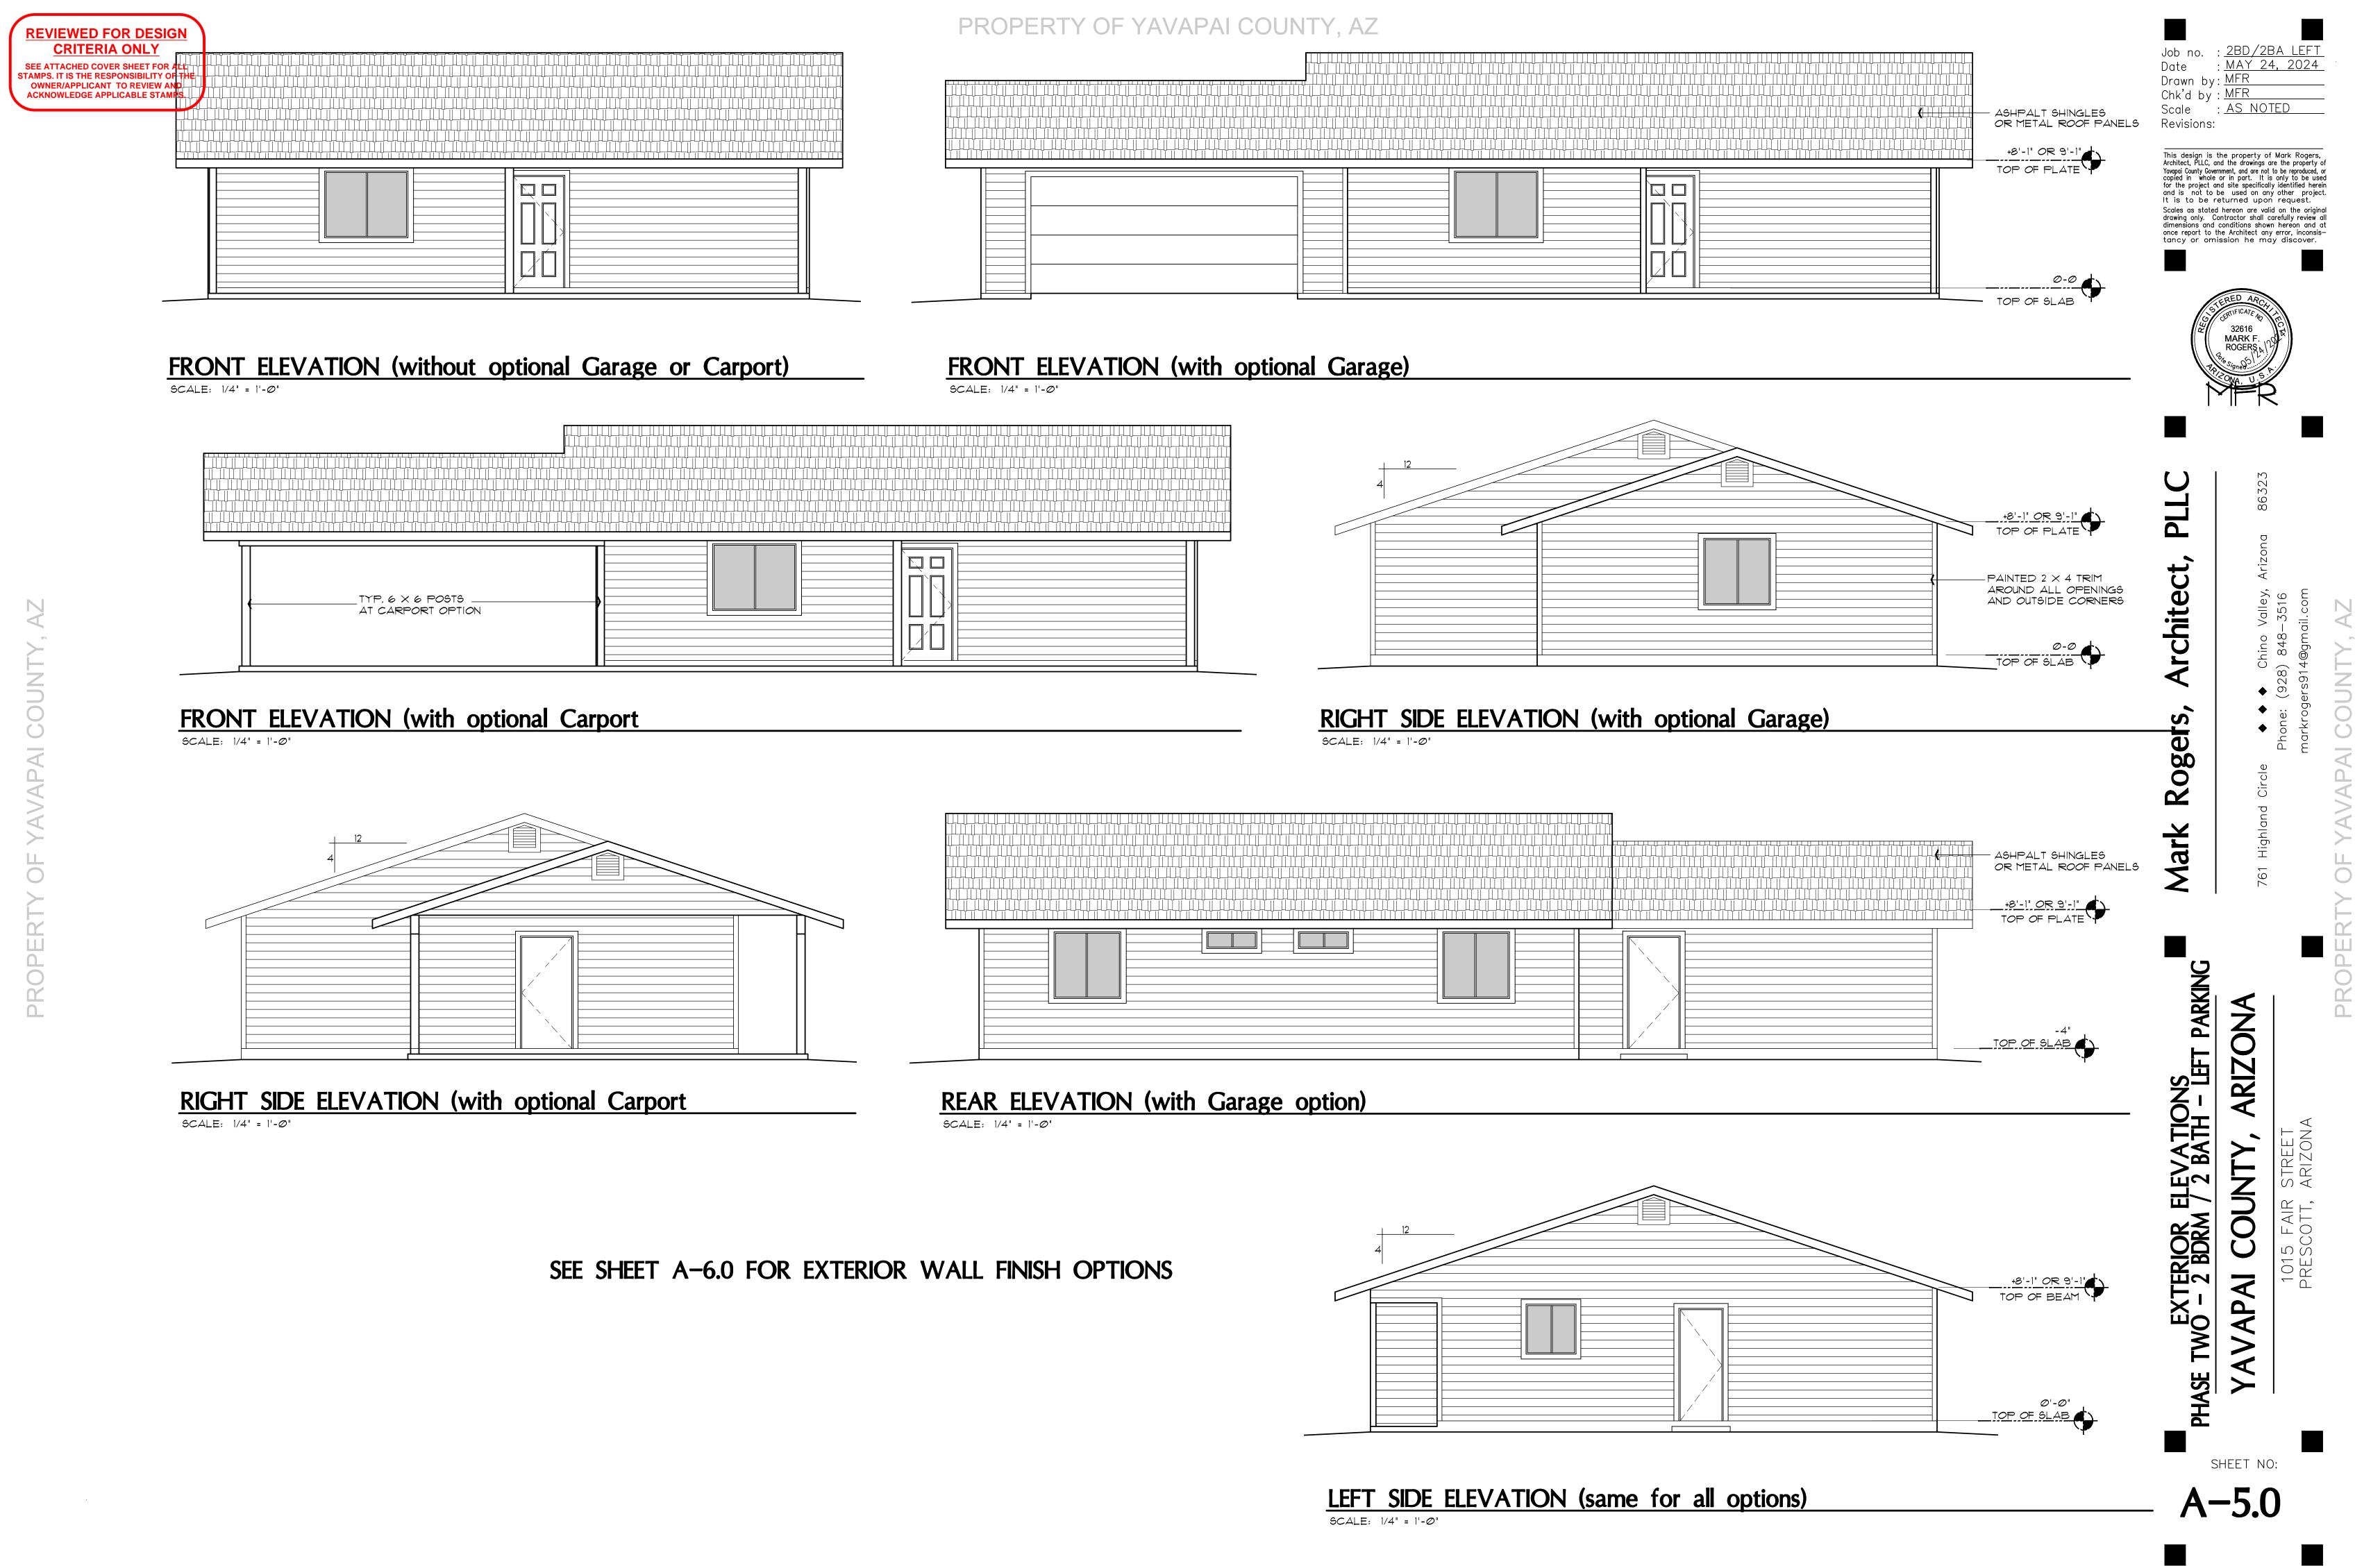

POST BASE FOOTING

4 THK. CONC. SLAB W/

TYPICAL TURN-DOWN FOOTING

4" COMP. ABC

#3 BARS AT 32" O.C. EA. WAY OVER

BCALE: 1" = 1'-0"

-2 imes FRIEZE BOARD (TYPICAL

 $-CONT. 2 \times 8$ PAINTED FASCIA

4" ALUMINUM DOWNSPOUTS AS SHOWN ON ROOF PLAN

SEE BRACE WALL PLAN SHEET FOR EXTERIOR WALL FINISH OPTIONS, OVER WEATHERPROOF MOISTURE/AIR BARRIER, ON 2 X 6 STUDS AT 16" O.C.

R-21 BATT INSULATION

TAPED, TEXTURED & PAINTED 1/2" DRYWALL AT WALLS AND CEILINGS **ROOF OVERHANG DETAIL**

> ASPHALT SHINGLES, OR METAL ROOF PANELS, OVER 15# MIN. ROOFING FELT, 1/2" OR 5/8" PLYWOOD, OR OSB SHEATHING, ON PRE-ENGINEERED TRUSSES AT 24" O.C.

> > R-38 BATT INSULATION INSULATION BAFFLE BETWEEN EACH TRUSS

- SIMPSON H2.5A (TYPICAL EACH TRUSS, UNLESS NOTED OTHERWISE) - 3 HOLE, 2" DIA. BIRDBLOCKING

WITH INSECT SCREENS -CONT. 4" ALUMINUM GUTTER

 $-CONT. 2 \times 8 PAINTED FASCIA$ - SIMPSON 'BC4' POST CAP (TYP.)

- 4" ALUMINUM DOWNSPOUTS AS SHOWN ON ROOF PLAN


 $_{-}$ 4 imes 4 PAINTED WOOD POST

-PAINTED 1/2" A/C PLYWOOD OR OSB

ATTACH ROOF SHEATHING W/8d COMMON NAIL (2 1/2" \times Ø.131") 6" O.C. AT EDGES, 12" O.C. FOR INTERMEDIATE SUPPORTS. PER IRC TABLE R602.3(1)

ROOF OVERHANG AT BEAM DETAIL

2'-Ø"

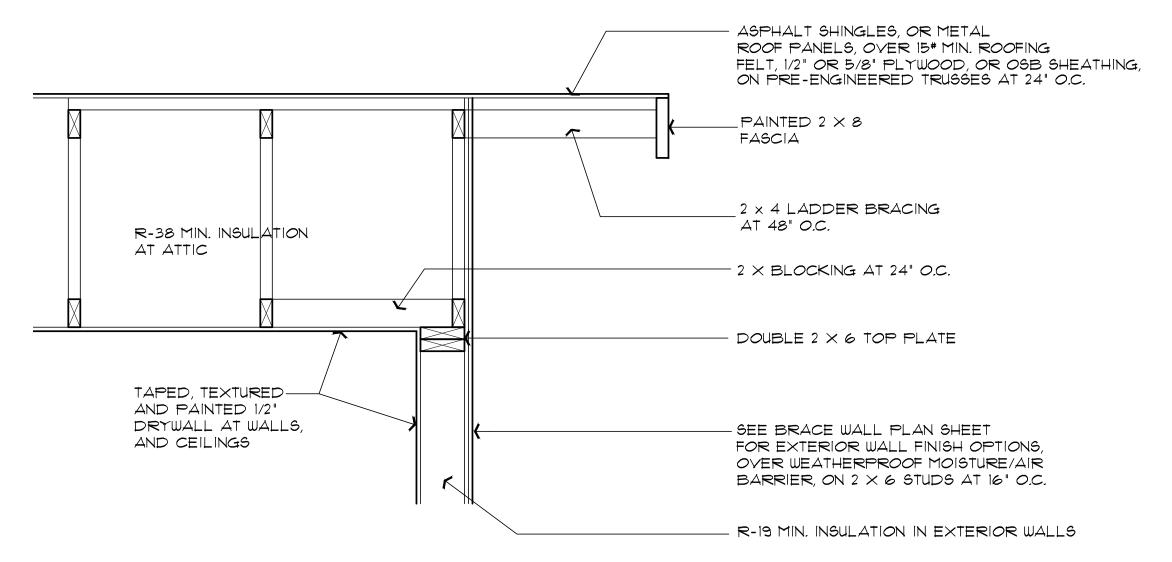


GABLE END-WALL DETAIL

CONCRETE STEM WALL OPTION 2 × 6 PRESSURE TREATED -BOTTOM PLATE W/ $1/2" \times 10"$ -4" THK. CONC. SLAB W/ #3 BARS -POSTS PER PLAN A.B. AT 48" O.C. AT 24" O.C. EACH WAY OVER 4" (EMBED MIN. 7" INTO FOUNDATION) COMP. ABC __2" RIGID INSUL. FOR 24" HORIZ. (1) #4 BAR CONT.-'SIMPSON' ABU44 FOR 4×4 POSTS ABU66 FOR 6 × 6 POSTS APPROX. FIN. GRADE -4" THK. CONC. SLAB W/ #3 BARS AT 32" O.C. EA. WAY OVER 4" COMP. ABC MINIMUM FOOTING DEPTHS BELOW ADJACENT GRADE, MAY BE 12" IF BELOW 4500' ELEVATION. VERIFY -(3)#4 BARS EACH WAY WITH THE GEOTECH REPORT. —(1) #4 BAR CONT. MIN. OF 3" CLEAR ABOVE BOTTOM OF FOOTING 2'-0 SQUARE -----2'-6" SQ. AT F3 FOOTINGS

MONOLITHIC FOOTING OPTION SCALE: 1" = 1'-0"

NOTE: SLAB INSULATION MAY BE ELIMINATED IF USING WINDOWS WITH 0.32 U-FACTOR OR BETTER.

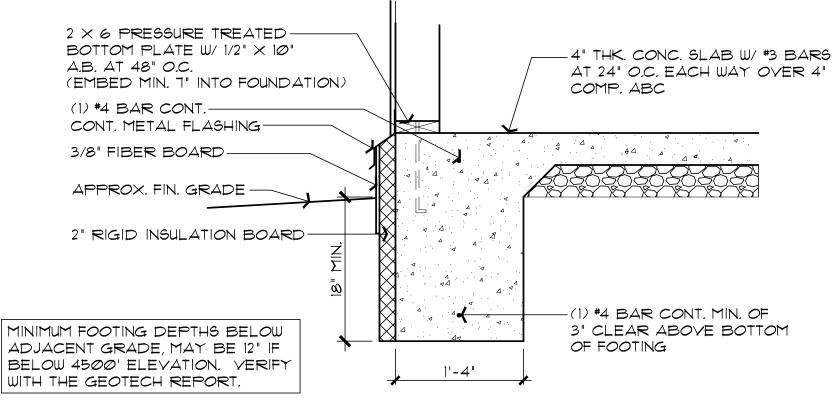

MONOLITHIC FOOTING OPTION WITH WF4 EXTERIOR SLAB INSULATION

Lange of the lange o oger Mar

MAY 24, 2024 MFR Drawn by Chk'd by : MFR AS NOTED Scale Revisions:

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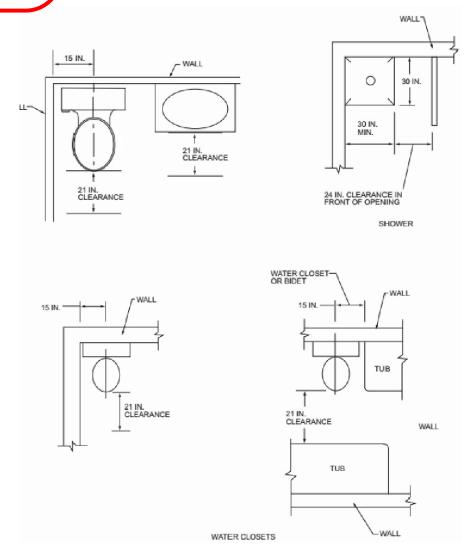
ARIZ

DETAILS - LEFT PARKING

ROOF 1 2 BATH

HASE TWO - 2 BDRM SHEET NO:

A - 7.0



PLUMBING FIXTURE CLEARANCES

NO SCALE PER IRC FIGURE R3Ø1.1

HVAC/PLUMBING GENERAL NOTES:

1. THE MECHANICAL CONTRACTOR SHALL DETERMINE THE FINAL EQUIPMENT SIZING, DUCT SIZING, AND DUCT LAYOUT PRIOR TO INSTALLATION. 2. DRAIN AND VENT SIZES TO BE DETERMINED BY PLUMBING CONTRACTOR.


3. WATER HEATER RELIEF VALVE SHALL EXTEND OUTSIDE OF THE BUILDING WITH THE END OF THE PIPE NOT MORE THAN 2' NOR LESS THAN 6" ABOVE THE GROUND AND POINTING DOWNWARD.

4. PROVIDE A PAN, AND DRAIN FOR THE WATER HEATER

5. THE CLOTHES DRYER EXHAUST DUCT SHALL BE AT LEAST THE DIAMETER OF THE APPLIANCE OUTLET AS RECOMMENDED BY THE MANUFACTURER AND SHALL TERMINATE AT THE EXTERIOR OF THE BUILDING. IT SHALL NOT EXCEED 25' IN LENGTH WITH REDUCTIONS FOR BENDS. THE DUCT SHALL TERMINATE NOT LESS THAN 3' FROM A PROPERTY LINE.

6. THE SITE PLAN SHALL INDICATE THE LOCATION OF THE GAS SOURCE THE DISTANCE AND PIPE SIZE FROM THE SOURCE, TO THE RESIDENCE, AND THE TYPE OF FUEL (NATURAL GAS OR PROPANE).


1. BI-FOLD DOOR AT WATER HEATER CLOSET SHALL BE LOUVERED FOR COMBUSTION AIR (MIN. REQUIREMENTS OF 100 SQ. INCHES OF FREE AIR).

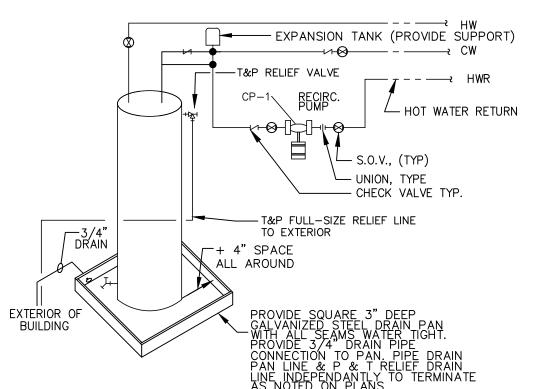


PROVIDE ACCESSABLE ELECTRICAL DISCONNECT

NOTE: DRAIN PAN, AND T&P MUST DRAIN BY GRAVITY. WATER HEATER SHALL BE HIGH ENOUGH

ELECTRIC WATER HEATER NO SCALE

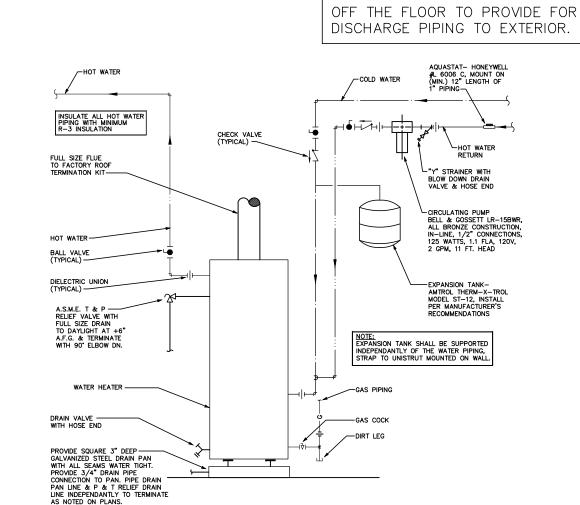


GAS WATER HEATER OPTION

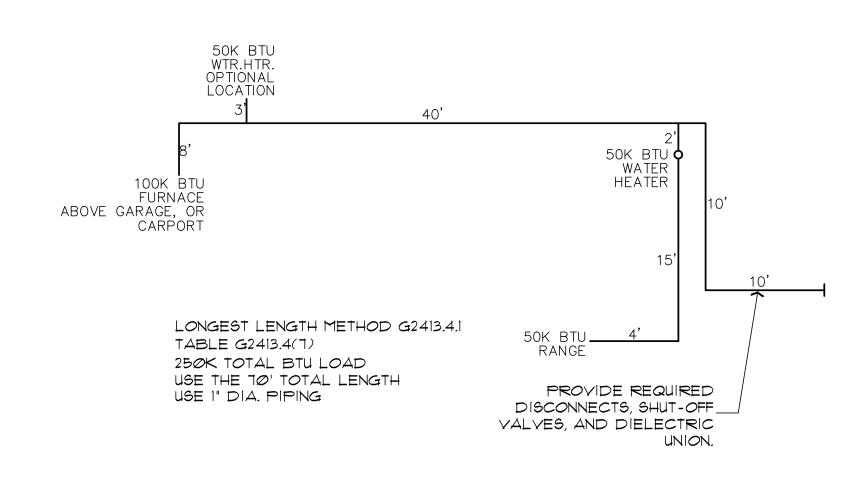

GAS PIPING ISOMETRIC

NOTE: USE 1" DIA. PIPING FOR ALL FLOOR PLAN LAYOUTS, INCLUDING. ALTERNATE FIXTURE LOCATIONS. THE PLUMBING CONTRACTOR SHALL SHALL VERIFY ALL SIZING, AND FITTINGS, PRIOR TO INSTALLATION.

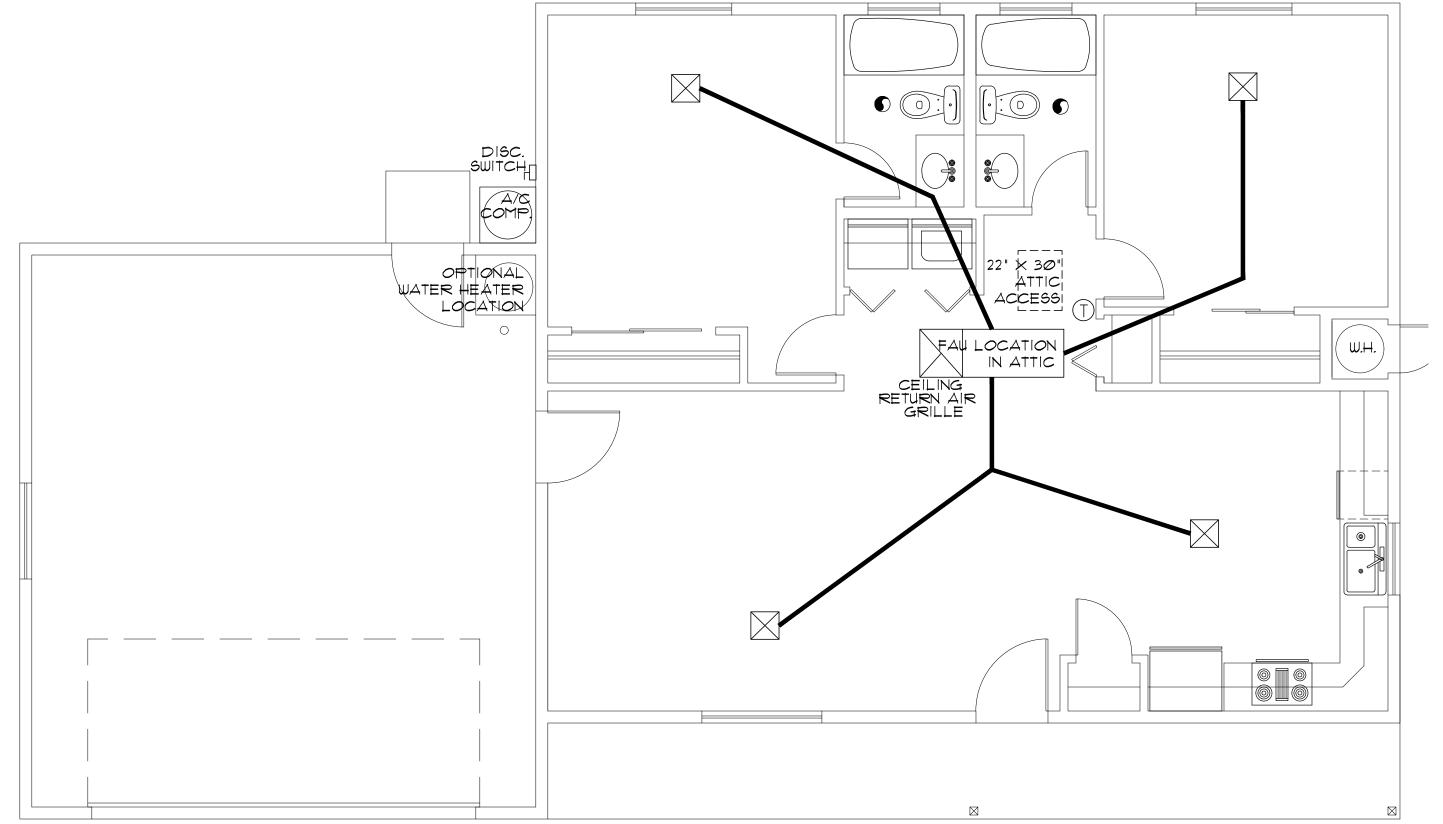


HVAC PLAN (furnace in attic above habitable area)

SCALE: 1/4" = 1'-0"

SUPPLY-AIR GRILL RETURN AIR GRILL

THERMOSTAT

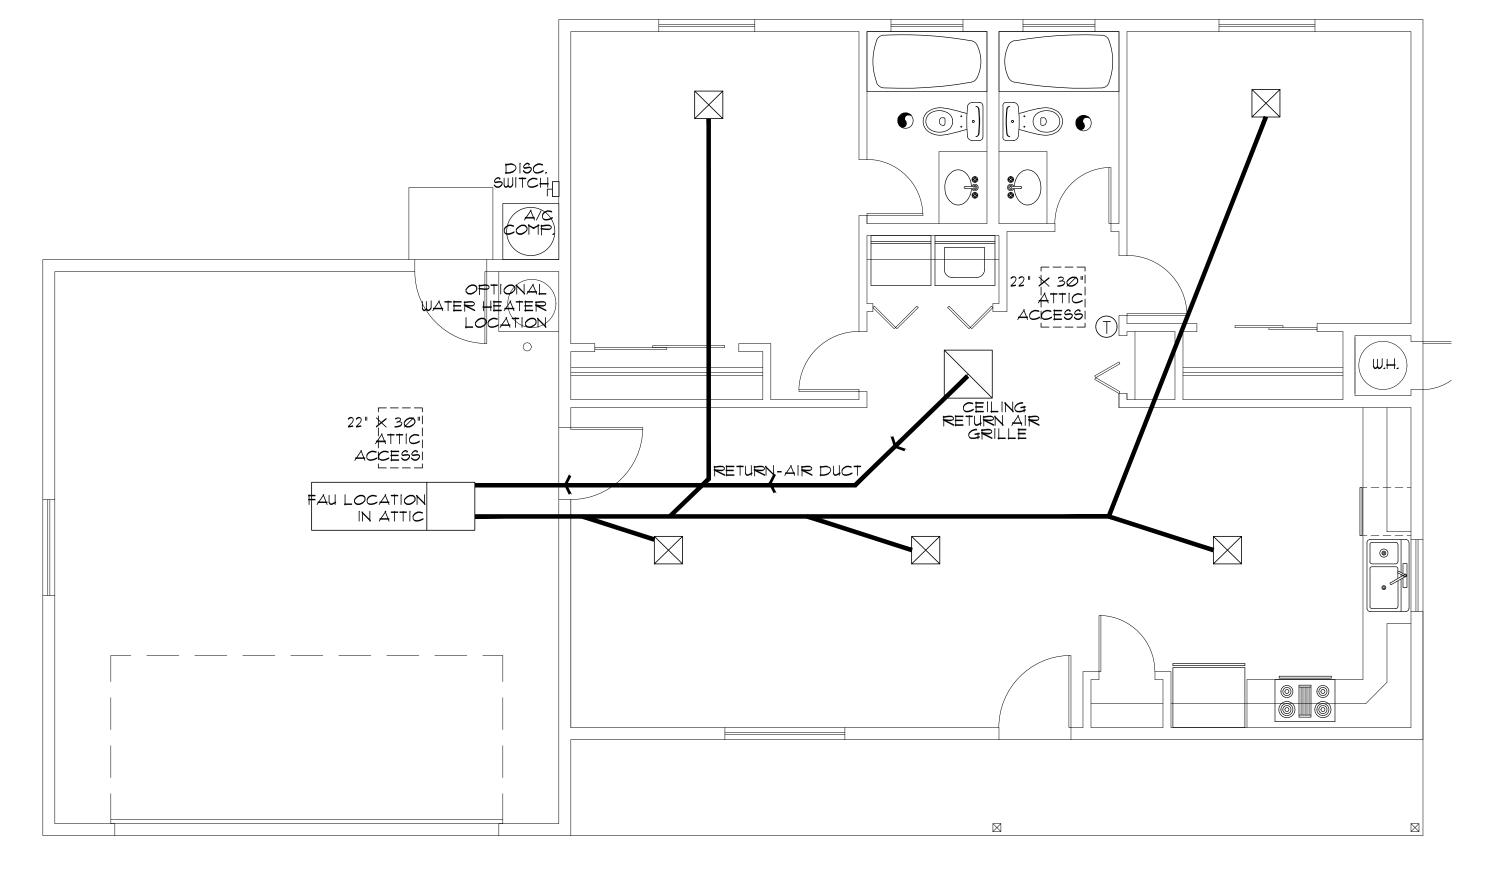

HVAC PLAN (furnace in attic above Garage, or Carport)

SCALE: 1/4" = 1'-0"

SHEET NO: M-1.0

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dimensions and conditions shown hereon and at once report to the Architect any error, inconsistancy or omission he may discover.

> 32616 MARK F.

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Drawn by:

Revisions:

Scale

Marl

LEFT PARKING

ARIZON

Chk'd by : MFR

ELECTRICAL SYMBOLS

----- WALL MOUNTED LIGHT FIXTURE

- DAMP-PROOF CEILING MOUNTED LIGHT FIXTURE

-CEILING MOUNTED LIGHT FIXTURE

- PENDANT LIGHT FIXTURE - RECESSED CAN FIXTURE

 $1' \times 4'$ SURFACE MTD. FLUORESCENT FIXTURE

— 110v. DUPLEX CONVENIENCE OUTLET MOUNTED 12" A.F.F., OR AS NOTED - 110v. 4-PLEX CONVENIENCE OUTLET MOUNTED 12" A.F.F., OR AS NOTED

-GROUND-FAULT INTERRUPT

. - WEATHER-PROOF GROUND-FAULT INTERRUPT

— 22Ø√ RECEPTACLE

- SINGLE POLE SWITCH MOUNTED

AT 48" OR AS NOTED

- 3-WAY SINGLE POLE SWITCH MOUNTED AT 48" OR AS NOTED

CEILING EXHAUST FAN

- SMOKE DETECTOR - SMOKE DETECTOR / CARBON MONOXIDE COMBO

-CABLE TY OUTLET


-CEILING FAN W/ LIGHT KIT

- DOORBELL BUTTON

TELEPHONE OUTLET


ELECTRICAL GENERAL NOTES

- 1. ALL WORKMANSHIP, MATERIALS, AND METHODS SHALL CONFORM TO N.E.C.- 2017 EDITION.
- 2. ALL HABITABLE ROOMS SHALL BE PROVIDED W/ ELECTRICAL OUTLETS SO THAT NO PART OF THE WALL IS MORE THAN 6' FROM AN OUTLET. WALL SECTIONS 2' OR LARGER & KITCHEN COUNTERS WIDER THAN 12" SHALL BE SERVICED BY A RECEPTACLE.
- 3. ALL RECEPTICALS IN BATHROOMS, OUTSIDE & WITHIN 6' OF WATER SOURCE SHALL BE G.F.C.I.
- 4. ALL SMOKE DETECTORS SHALL BE INTERCONNECTED ON SEPARATE CIRCUIT & SHALL RECEIVE PRIMARY POWER FROM BUILDING WIRING \$ SHALL HAVE BATTERY BACKUP. CONNECT NEW SMOKE DETECTORS TO NEW AUDIBLE SYSTEM INSIDE EXISTING RESIDENCE.
- 5. LIGHTS IN CLOSETS SHALL BE 18" FROM SHELVING (MEASURED HORZTL. OR BE RECESSED.
- 6. PROVIDE MINIMUM TWO 20A BRANCH CIRCUITS FOR RECEPTACLES LOCATED IN THE KITCHEN, PANTRY, EATING AREA, A SEPARATE 20A BRANCH CIRCUIT TO THE LAUNDRY EQUIP., AND A SEPARATE 2014 BRANCH CIRCUIT FOR BATHROOM RECEPTACLES.
- 1. ALL BRANCH CIRCUITS THAT SUPPLY 120-VOLT SINGLE PHASE 15 & 20 AMP OUTLETS INSTALLED IN FAMILY ROOMS, DINING ROOMS LIVING ROOMS, PARLORS, LIBRARIES, DENS, BEDROOMS, SUNROOMS RECREATION ROOMS, CLOSETS, HALLWAYS AND SIMILAR ROOMS OR AREAS SHALL BE PROTECTED BY COMBINATION TYPE ARC FAULT CURCUIT INTERUPTERS INSTALLED TO PROVIDE PROTECTION OF THE
- 8. FIXTURES, FITTINGS, BOXES AND RECEPTACLES LOCATED IN DAMP OR WET LOCATIONS SHALL BE 'LISTED' TO BE SUITABLE FOR SUCH CONDITIONS.
- 9. CONTRACTOR TO EMBED 20' OF #4 AWG COPPER WIRE IN FOOTING FOR ELECTRICAL SERVICE GROUND, PROVIDE BONDING TO THE INTERIOR WATER PIPING AND ABOVE GROUND PORTION OF GAS PIPING SYSTEM.
- 10. IN KITCHEN AND DINING ROOMS A RECEPTACLE OUTLET SHALL BE INSTALLED AT EACH WALL COUNTER SPACE 12" OR WIDER SO THAT AT NO POINT ALONG THE WALL IS MORE THAN 24" FROM A RECEPTACLE OUTLET AND SHALL BE GFCI PROTECTED.
- 11. PROVIDE AT LEAST ONE WEATHER PROOF RECEPTACLE OUTLET NOT MORE THAN 6'-6" ABOVE GRADE AND GFCI PROTECTED. AT THE FRONT AND BACK OF EACH DWELLING. ALL RECEPTACLES INSTALLED OUTDOORS MUST BE GFC! PROTECTED.
- 12. ALL EXTERIOR LIGHTING SHALL CONFORM TO YAVAPAI COUNTY DARK SKY ORDINANCE.
- 13. IN ATTICS, A SERVICE OUTLET & LIGHTING FIXTURE LOCATED NEAR THE APPLIANCE REQUIRING SERVICE SHALL BE CONTROLLED BY A SWITCH AT THE ENTRY OF THE ATTIC. (REQUIRED FOR ATTIC MOUNT FURNACES)

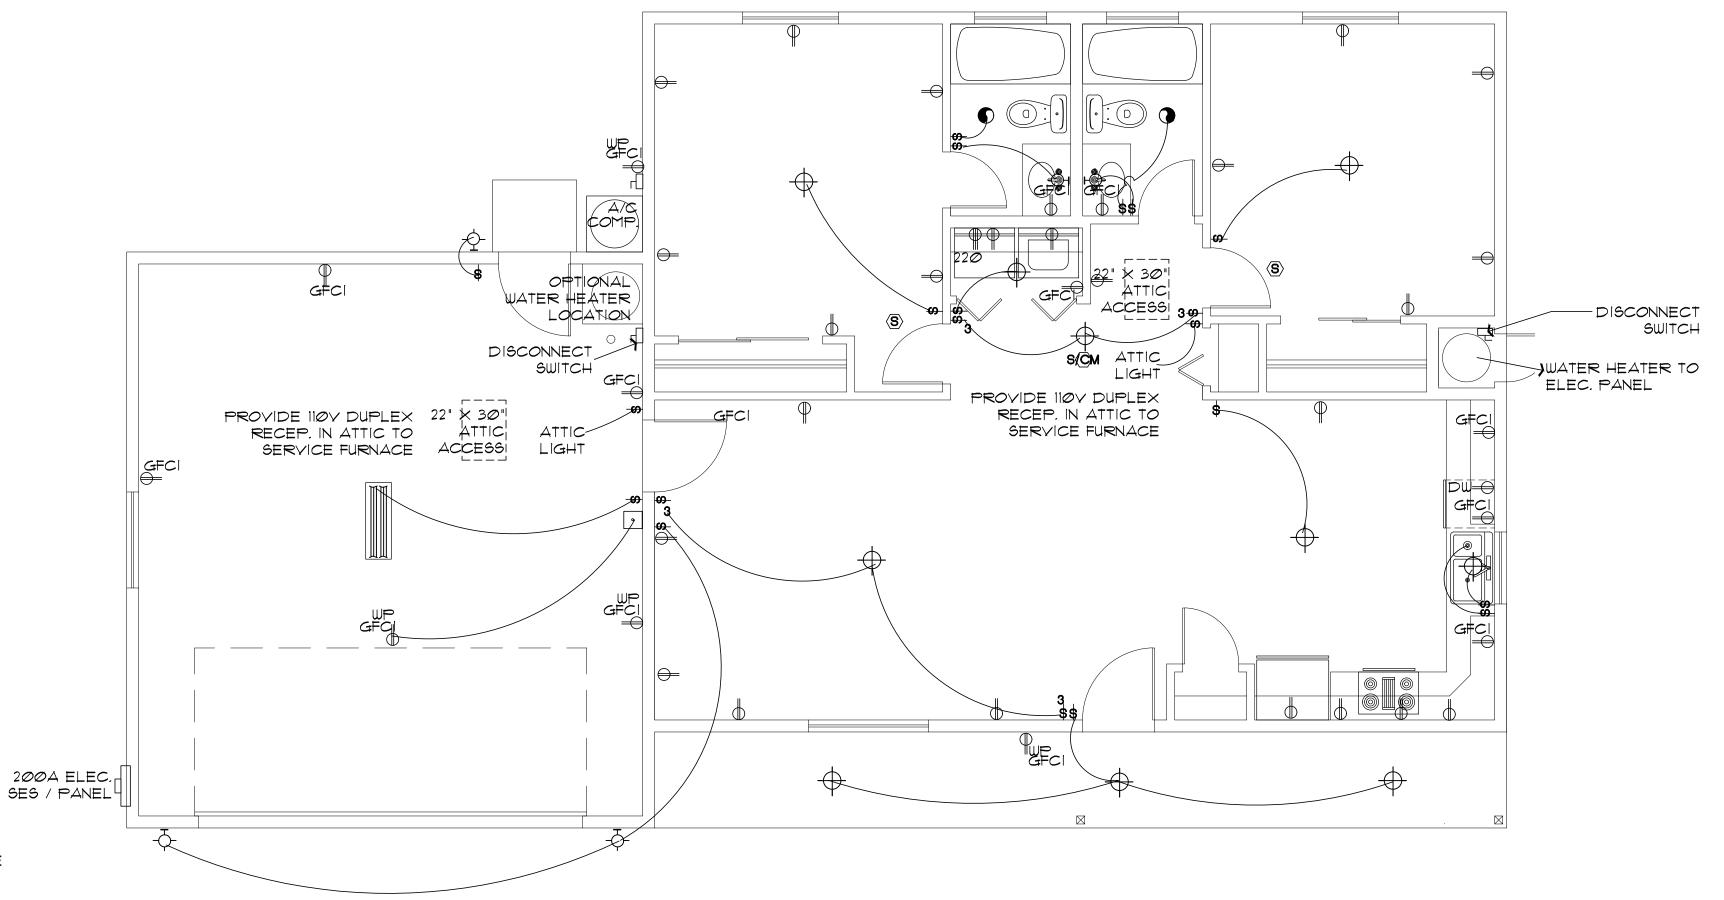

ELECTRICAL PLAN (with Garage option)

SCALE: 1/4" = 1'-0"

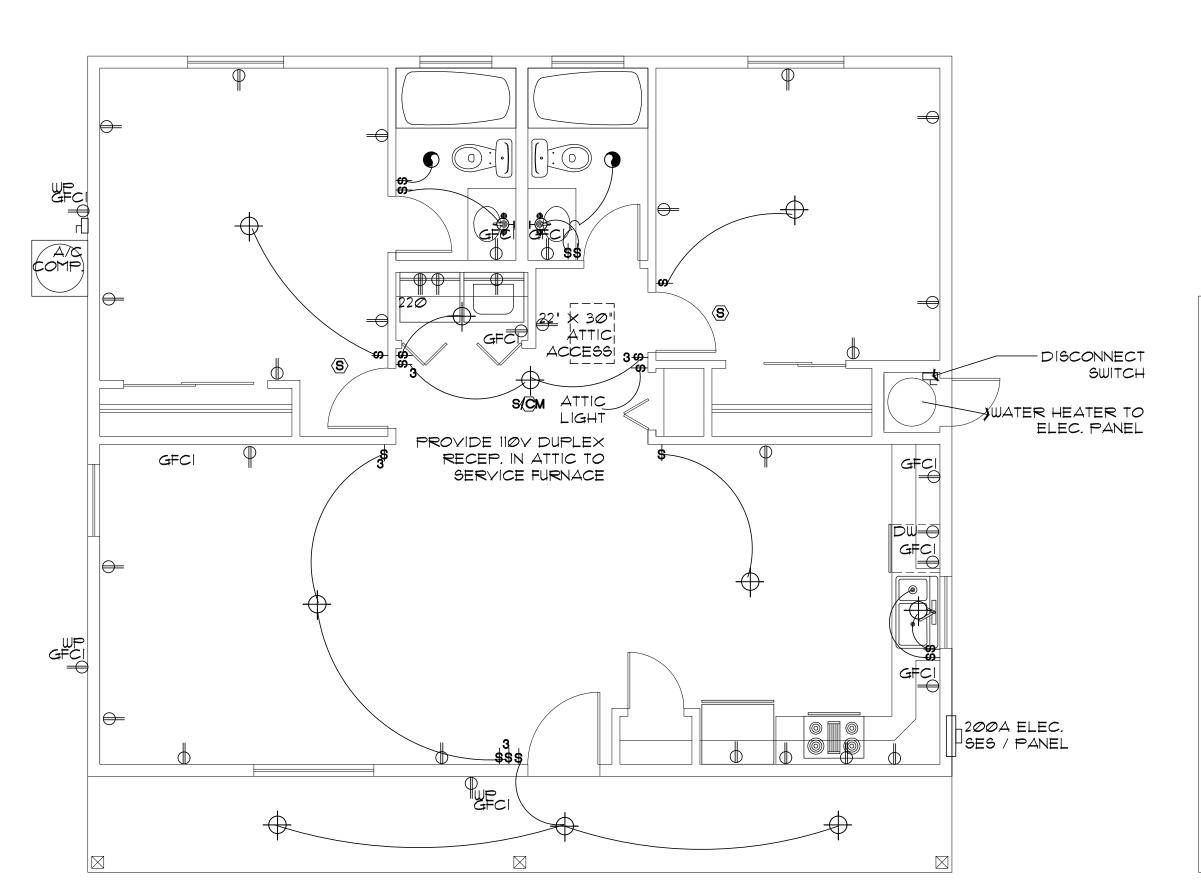

ELECTRICAL PLAN (without Garage, or Carport option) SCALE: 1/4" = 1'-0"

COMP) — DISCONNECT SWITCH JWATER HEATER ELEC. PANEL PROVIDE 110V DUPLEX RECEP. IN ATTIC TO SERVICE FURNACE PROVIDE 110V DUPLEX 22" X 30" |
RECEP. IN ATTIC TO ATTIC |
SERVICE FURNACE ACCESSI ATTIC_ LIGHT 200A ELEC. SES / PANEL 200A ELEC. SES / PANEL

SCALE: 1/4" = 1'-0"

ELECTRICAL PLAN (with Carport option)

ARIZON/

8

MAY <u>24, 2024</u>

AS NOTED

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32616

ROGERS N

MARK F.

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Scale Revisions:

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SHEET NO:

E-1.0

SYMBOL TWO - 2